#### DESIGN REVIEW BOARD Monday September 8, 2025 7:30 p.m.

#### Virtual Meeting using Zoom

Meeting ID: 837 5422 1747 (Instructions for accessing below)

Under Governor Baker's Act "Extending Certain COVID-10 Measures Adopted During the State of Emergency", extending the "Executive Order Suspending Certain Provisions of the Open Meeting Law G.L. c. 30A, S20,", issued June 16, 2021, and extended several times again through 2027, meeting of public bodies could be conducted virtually provided that adequate access is provided to the public.

To view and participate in this virtual meeting on your phone, download the "Zoom Cloud Meetings" app in any app store or at <a href="https://www.zoom.us">www.zoom.us</a>. At the above date and time, click on "Join a Meeting" and enter the following Meeting ID: 837 5422 1747 Link: <a href="https://us02web.zoom.us/j/8375422">https://us02web.zoom.us/j/8375422</a> 1747

To view and participate in this virtual meeting on your computer, at the above date and time, go to www.zoom.us click "Join a Meeting" and enter the following ID: 837 5422 1747

#### **HEARINGS:**

None

#### **APPLICANTS:**

Gary McCoy, Poyant Signs Inc., representing Hyannis Port Research located at 400 First Avenue, Needham, MA, and applying for signage.

Joe Garber, Riverside Community Care located at 237 Highland Avenue, Needham, MA, and applying for exterior alterations.

Kayla Sepulveda, Sullivan & Comerford, P.C. representing Chabad Lubavitch Jewish Center to be located at 1195 Central Avenue and applying for site plan review.

Tim Sullivan, Goulston & Storrs representing Greystar Development East, LLC applying for redevelopment of 100 West Street and site plan review.

#### **REVIEW**

Minutes of 8/11/2025 meeting.

Next Public Meeting - September 29, 2025 at 7:30pm



### TOWN OF NEEDHAM

#### DESIGN REVIEW BOARD


Public Service Administration Building 500 Dedham Avenue Needham, MA 02492 **Application and Report** 

Property L	ocation: 400 1st Avenue, Nee	dham, MA 02494	Date	. 08/20/25
)wner:	HPR			
Address:	400 1st Avenue	Needham	MA	02494
Telephone.	Street : 339-933-1338	City	State	Zip
pplicant:	Poyant Signs/ Gary McCoy			
Address:	125 Samuel Barnet Boulevard	New Bedford	MA	02745
elephone:	Street . 508-328-1457	City	State	Zip
ddress:	Street 509 229 1457	City	State	Zip
etepnone.	<ul><li>□ - preliminary</li><li>□ - final</li><li>□ Flexible Subdiv</li></ul>	tions (Site Plan Review) rision ential Development		
Brief descri	ption of sign or project: Install new tenant si	ign - (1) Halo Illuminated (	Channel Lette	rs (99.5 Sq l
	Sign #1 on Site Pla	•		· ·

Please email completed application to elitchman@needhamma.gov

Hyannis Port Research | 400 First Ave, Needham, MA | Design Development | May 22, 2025



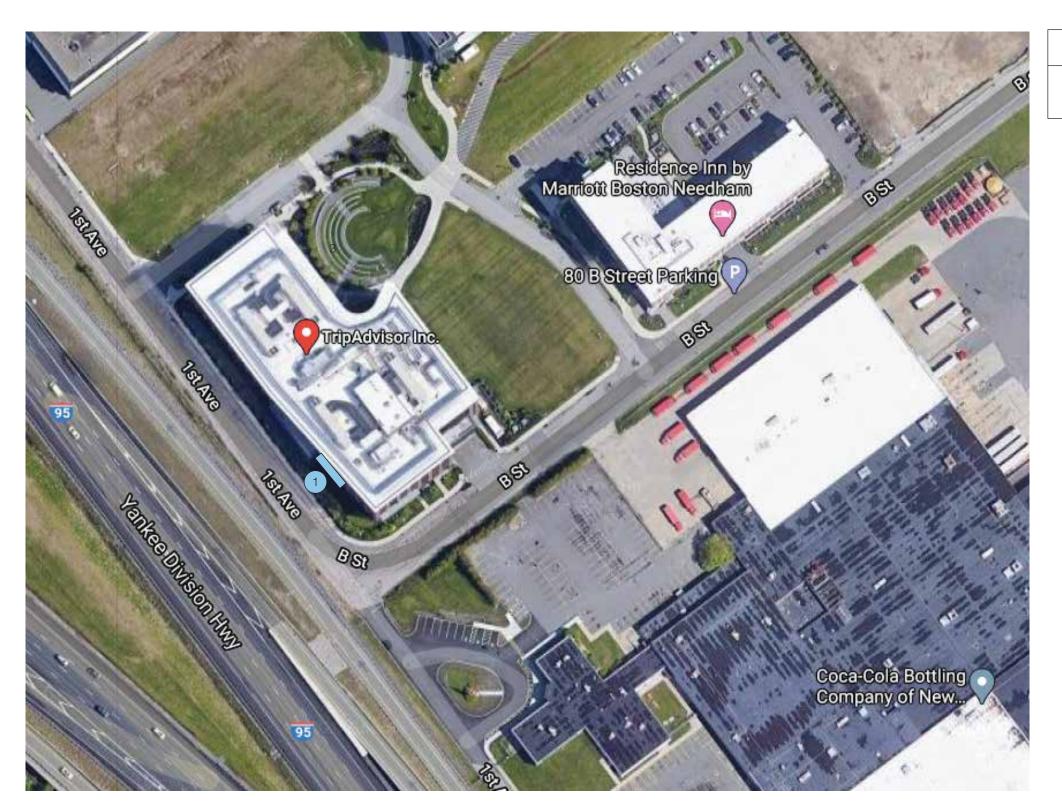

A Site Plan - Plan View Not to Scale

Sign Type Key



1 Advisor 360 Sign - Page 1A

Poyant Building Your Brand

125 Samuel Barnet Boulevard New Bedford, MA 02745 800.544.0961 poyantsigns.com

#### Hyannis Port Research

400 First Ave Needham, MA

Project: 26188 Advisor 360


Sales: Gary McCoy Date: 05.22.25 Designer: EB

#### Note:

This is an original unpublished drawing created by Poyant Signs, Inc. It is submitted for your personal use in connection with a project being planned for you by Poyant Signs, Inc. It is not to be shown to anyone outside your organization, nor is it to be reproduced, copied or exhibited in any fashion until transferred.


Revisions:
This sign is intended to be installed in accordance with the requirements of Article 600 of the National Electrical Code and / or other applicable local codes. This includes proper grounding and bonding of the sign.
Approved By:
Date:

Site Plan

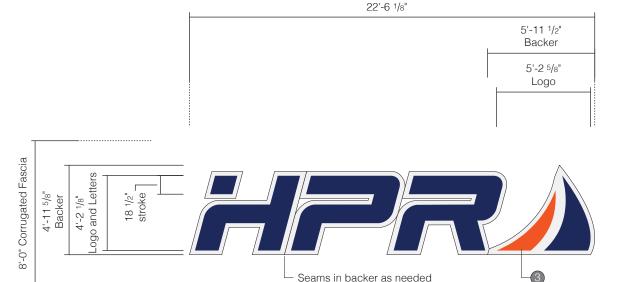



Sign Elevation - Front View Scale: 3/16"=1'-0"

Not to Scale

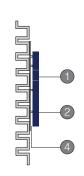

Sign Elevation - Side View Scale: 3/16"=1'-0"

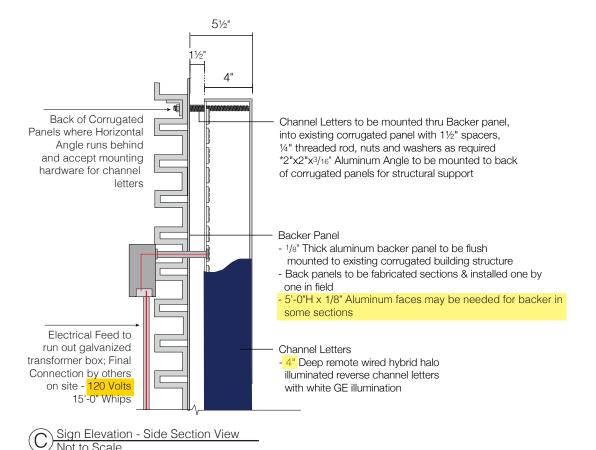

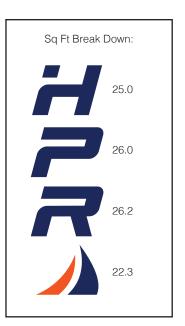

Total = 99.5 Sq Ft

#### Specifications

99.5 Sq Ft Qty = 1

#### Halo Illuminated Channel Letters

- Flush mount to corrugated panel
- Power supplies to be concealed within galvanized transformer box contained behind corrugated fascia
- \*All secondary wires to be concealed within liquid tight
- (Qty:2) Horizontal rows of 2"x2"x3/16" aluminum angle mounted to back of corrugated panels to accept mounted hardware from channel letters \*Aluminum Angle Supports may have to be trimmed in field due to
- Channel Letters to have a dimmer switch to allow client to dim brightness of letters if needed later on

#### Provided By Others - All below to be provided by others

- Primary electrical connection by others

#### Verify in Field (VIF)

- Confirm Measurements of Fascia
- Confirm building has not changed at our install areas since
- Confirm voltage requirements, electrical location & access

#### Colors & Materials



Blue; Satin Finish - Pantone 2757C Logo/Letters Faces & Returns



Orange; Satin Finish - Pantone 021C Logo Face & Returns



Paint

White: Matte Finish Backer Panel



Spacers Silver - Aluminum Mill Finish



125 Samuel Barnet Boulevard New Bedford, MA 02745 800.544.0961 poyantsigns.com

#### Hyannis Port Research

400 First Ave Needham, MA

Project: 26188 Advisor 360

Sales: Gary McCoy Date: 05.22.25 Designer: EB

#### Note:

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Revisions:	



This sign is intended to be installed in accordance with the requirements of Article 600 of the National Electrical Code and / or other applicable local codes. This includes proper grounding and bonding of the sign.

Approved By:

Date:

Halo Lit Channel Letters KOM Requested/Similar Sign: 17598.1B-R4

Option A

1A.1 1 of 3





Center Within Glass

Photo Comp - Existing
Not to Scale

Photo Comp - Proposed
Not to Scale

Elevation - 1st Avenue
Not to Scale



125 Samuel Barnet Boulevard New Bedford, MA 02745 800.544.0961 | poyantsigns.com

#### Hyannis Port Research

400 First Ave Needham, MA

Project: 26188 Advisor 360

Sales: Gary McCoy Date: 05.22.25 Designer: EB

#### Note:

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This sign is intended to be installed in accordance with the requirements of Article 600 of the National Electrical Code and / or other applicable local codes. This includes proper grounding and bonding of the sign.

Approved By:


Revisions:

Date:

Halo Lit Channel Letters

KOM Requested/Similar Sign: 17598.1B-R4

Option A

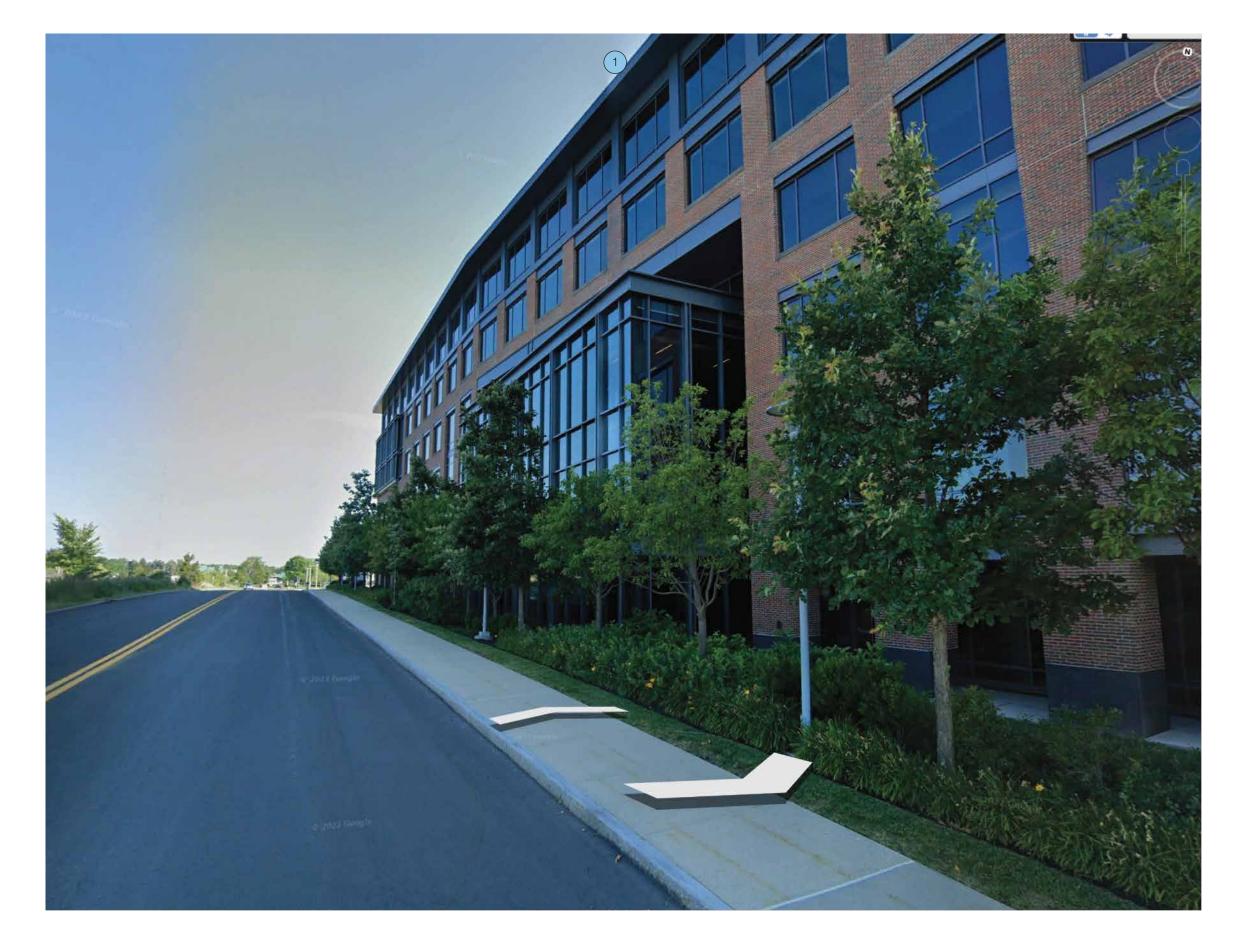

A Elevation - First Avenue Approach
Not to Scale



125 Samuel Barnet Boulevard New Bedford, MA 02745 800.544.0961 poyantsigns.com

#### Hyannis Port Research

400 First Ave Needham, MA

Project: 26188 Advisor 360

Sales: Gary McCoy Date: 05.22.25 Designer: EB

#### Note:

Note:
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Revisions:	



This sign is intended to be installed in accordance with the requirements of Article 600 of the National Electrical Code and / or other applicable local codes. This includes proper grounding and bonding of the sign.

Approved By:

Date:

Halo Lit Channel Letters
KOM Requested/Similar Sign: 17598.1B-R4

Option A





Center Within Glass

A Photo Comp - Existing
Not to Scale

Photo Comp - Proposed
Not to Scale

**Tripadvisor** HPRA

Elevation - 1st Avenue Not to Scale

Poyant

125 Samuel Barnet Boulevard New Bedford, MA 02745 800.544.0961 poyantsigns.com

Hyannis Port Research

400 First Ave Needham, MA

Project: 26188 Advisor 360

Sales: Gary McCoy Date: 05.22.25 Designer: EB

Note:

Note:
This is an original unpublished drawing created by Poyant Signs, Inc. It is submitted for your personal use in connection with a project being planned for you by Poyant Signs, Inc. It is not to be shown to anyone outside your creanization port is it to be organization, nor is it to be reproduced, copied or exhibited in any fashion until transferred.



This sign is intended to be installed in accordance with the requirements of Article 800 of the National Electrical Code and / or other applicable local codes. This includes proper grounding and bonding of the sign.

Approved By:

Date:

Halo Lit Channel Letters KOM Requested/Similar Sign: 17598.1B-R4

Option A

Sign Type 26188.1A

1A.2 2 of 3



#### TOWN OF NEEDHAM

#### DESIGN REVIEW BOARD

Public Service Administration Building 500 Dedham Avenue Needham, MA 02492 **Application and Report** 


Property L	Location: 237 Highland Ave		Dat	te: 09/02/2025
Owner:	Riverside Community Care			
Address:	270 Bridge St. Suite 301	Dedham	MA.	02026
Telephone	Street 978-989-1138	City	State	Zip
Applicant:	Joe Garber- Facilities Manage	er Riverside Com	munity Ca	re
Address:	jgarber@riversidecc.org			
Telephone.	Street : 978-989-1138	City	State	Zip
Designer/I	Installer: Means Pre-Cast			
Address:	151 Adams St.	Quincy	MA.	02184
	Street	City	State	Zip
Telephone.	781-843-1909			
	Type of Application  □ Sign □ Minor Project □ Exterior Alterations  Major Project (Site I □ - preliminary □ - final □ Flexible Subdivision □ Planned Residential □ Residential Compou	Development		

Brief description of sign or project: In the front of 237 Highland we a elevated concrete walkway that spans across the three entry doors

of our building the concrete is deteriorating so we are going to remove it and replace it with three

individual pre-cast concrete stairways with metal tubular railings that meet current code. We will have todo some asphalt work on our existing sidewalk to meet all our new stairways.

Please email completed application to elitchman@needhamma.gov

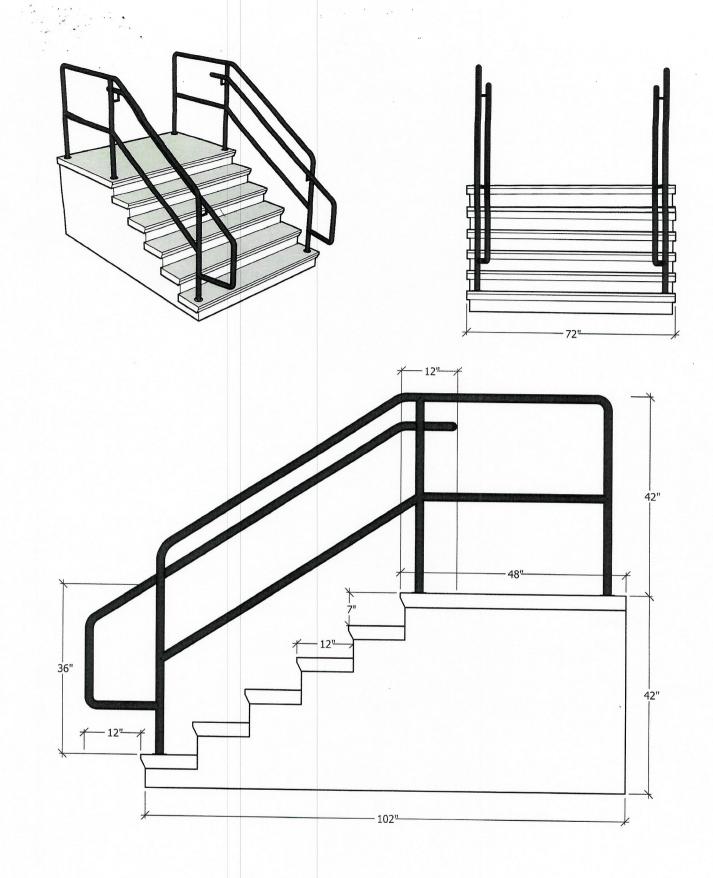





PRODUCT TITLE:

6' WIDE, 6 RISER, 48" PLATFORM WITH 7" RISE DATE:8/16/2025

WEIGHT:

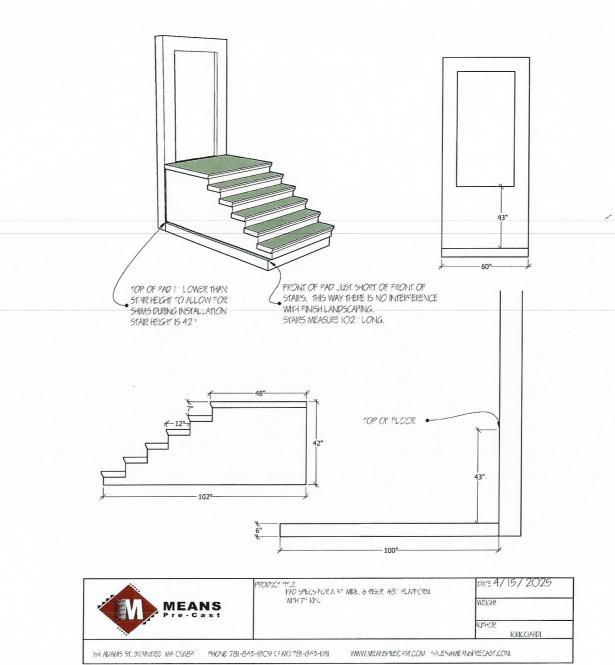

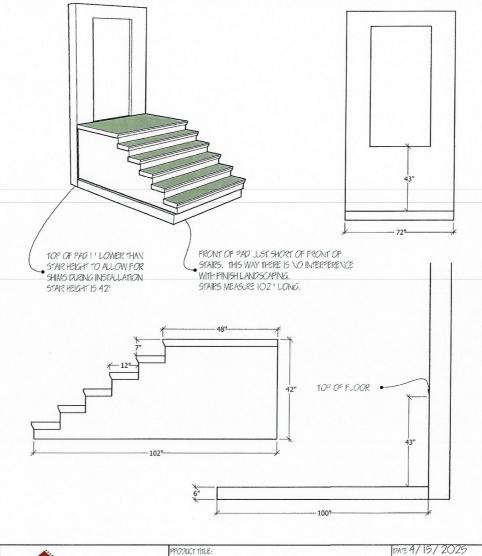













### TOWN OF NEEDHAM

#### DESIGN REVIEW BOARD

Public Service Administration Building 500 Dedham Avenue Needham, MA 02492 **Application and Report** 

Property Location: 1195 Central Avenue				Date:			
Owner:	CHABAD LUBAVITCH JEWISH CENTER OF NEEDHAM, INC.						
Address:		< Street	Needham	MA	02492		
Telephone	Street ::		City	State	Zip		
Applicant	: CHABAD LUE	BAVITCH JEWISH CEN	ITER OF NEEDH	AM, INC.			
Address:	_	Street			02492		
Telephone	Street ::		City	State	Zip		
Designer/Address:	Installer: Josie  1749 Central	Scarponi, KSID, LLC Street, Suite 2	Stoughton City	MA State	02072 Zip		
Telenhone	Telephone: _781-886-6973						
	iption of sign or p	Type of Application  Sign  Minor Project  Exterior Alterations  Major Project (Site Plant - preliminary - final  Flexible Subdivision  Planned Residential Dev	ı Review)				
		ocated at 1195 Central	Avenue are to be	razed and A	applicant propose		
to constr	ruct a 5,845 s.f.	Chabad and 3,135 s.f.	house.				

Please email completed application to elitchman@needhamma.gov



Project #: 22410

NEEDHAM CHABAD 1195 CENTRAL AVENUE NEEDHAM, MA

ARCHITECTURAL REVIEW BOARD SUBMISSION

Revisions:

		_
lo.:	Issue:	Date:

Scale: AS NOTED

Date: AUGUST 4, 2025

Drawing Title:

EXTERIOR RENDERING

Sheet No.:



SEED MIX 1 Non-Mowed/ Annual Mowing Area Seed Mix: Showy Northeast Native Wildflower & Grass Mix Seed specification from Ernst Seeds mix: ERNMX-153, or equal Little Bluestem, Fort Indiantown Gap-PA Ecotype (Schizachyrium scoparium, Fort Indiantown Gap-PA Ecotype) Sideoats Grama, 'Butte' (Bouteloua curtipendula, 'Butte') Virginia Wildrye, PA Ecotype (Elymus virginicus, PA Ecotype) Tall White Beardtongue, PA Ecotype (Penstemon digitalis, PA Ecotype) Partridge Pea, PA Ecotype (Chamaecrista fasciculata (Cassia f.), PA Ecotype) Purple Coneflower (Echinacea purpurea) Marsh (Dense) Blazing Star (Spiked Gayfeather) (Liatris spicat a) Butterfly Milkweed (Asclepias tuberosa) 2% Lanceleaf Coreopsis, Coastal Plain NC Ecotype (Coreopsis lanceolata) Coastal Plain NC Ecotype) 2% Oxeye Sunflower, PA Ecotype (Heliopsis helianthoides, PA Ecotype) Blackeyed Susan, Coastal Plain NC Ecotype (Rudbeckia hirta, Coastal Plain NC Ecotype) 2% 1.5% New England Aster (Aster novae-angliae (Symphyotrichum n.)) 1.5% Smooth Blue Aster, NY Ecotype (Aster laevis (Symphyotrichum laeve), NY Ecotype) 1.5% Ohio Spiderwort, PA Ecotype (Tradescantia ohiensis, PA Ecotype) 1% Autumn Bentgrass, Albany Pine Bush-NY Ecotype (Agrostis perennans, Albany Pine Bush-NY Ecotype) 0.8% Browneyed Susan, WV Ecotype (Rudbeckia triloba, WV Ecotype) Wild Senna, VA & WV Ecotype (Senna hebecarpa (Cassia h.), VA & WV Ecotype) Wild Bergamot, Fort Indiantown Gap-PA Ecotype (Monarda fistulosa, Fort Indiantown Gap-PA Ecotype) 0.5% Maryland Senna (Senna marilandica (Cassia m.)) 0.5% Blue False Indigo, Southern WV Ecotype (Baptisia australis, Southern WV Ecotype) 0.5% Early Goldenrod, VA Ecotype (Solidago juncea, VA Ecotype) 0.2% Hoary Mountainmint, MD Ecotype (Pycnanthemum incanum, MD Ecotype) Total: 100%

## Conservation Seed Mix:

Showy Northeast Native Wildflower & Grass Mix Seed specification from Ernst Seeds mix: ERNMX-153, or equal

Little Bluestem, Fort Indiantown Gap-PA Ecotype (Schizachyrium scoparium, Fort Indiantown Gap-PA Ecotype) 20% Sideoats Grama, 'Butte' (Bouteloua curtipendula, 'Butte')

18% Virginia Wildrye, PA Ecotype (Elymus virginicus, PA Ecotype) Tall White Beardtongue, PA Ecotype (Penstemon digitalis, PA Ecotype) 4%

4% Partridge Pea, PA Ecotype (Chamaecrista fasciculata (Cassia f.), PA Ecotype) 3% Purple Coneflower (Echinacea purpurea) 2.5% Marsh (Dense) Blazing Star (Spiked Gayfeather) (Liatris spicat a)

2% Butterfly Milkweed (Asclepias tuberosa) 2% Lanceleaf Coreopsis, Coastal Plain NC Ecotype (Coreopsis lanceolata,

Coastal Plain NC Ecotype) Oxeye Sunflower, PA Ecotype (Heliopsis helianthoides, PA Ecotype) 2%

Blackeyed Susan, Coastal Plain NC Ecotype (Rudbeckia hirta, Coastal Plain NC Ecotype) 1.5% New England Aster (Aster novae-angliae (Symphyotrichum n.)) 1.5% Smooth Blue Aster, NY Ecotype (Aster laevis (Symphyotrichum laeve), NY Ecotype) 1.5% Ohio Spiderwort, PA Ecotype (Tradescantia ohiensis, PA Ecotype)

1% Autumn Bentgrass, Albany Pine Bush-NY Ecotype (Agrostis perennans, Albany Pine Bush-NY Ecotype)

Browneyed Susan, WV Ecotype (Rudbeckia triloba, WV Ecotype) 0.5% Wild Senna, VA & WV Ecotype (Senna hebecarpa (Cassia h.), VA & WV Ecotype) 0.5% Wild Bergamot, Fort Indiantown Gap-PA Ecotype (Monarda fistulosa, Fort


Indiantown Gap-PA Ecotype) 0.5% Maryland Senna (Senna marilandica (Cassia m.))

0.5% Blue False Indigo, Southern WV Ecotype (Baptisia australis, Southern WV Ecotype) Early Goldenrod, VA Ecotype (Solidago juncea, VA Ecotype)

0.2% Hoary Mountainmint, MD Ecotype (Pycnanthemum incanum, MD Ecotype) Total: 100%

## <u>Planting Notes</u>

- 1. The Contractor is responsible for the legal removal and disposal of all debris from the site and as may be directed by the Owner
- Coordinate final locations of Site Improvements with the Civil and Architectural plans. The Contractor shall notify DIG-SAFE (1888-344-7233) to verify the location of any underground utilities prior to any digging.
- 4. All plant material and planting procedures shall conform to the "American Standard for Nursery Stock" as published by the American Nursery and Landscape Association. Contractor to stake proposed locations of all new plant material for LA review prior to
- Plant List governs: Contractor to provide plants on list. Locations and quantities in planting
- areas are subject to change under the discretion of the LA. The Contractor shall supply all plant materials in quantities sufficient to complete the shown
- 8. All plant materials are subject to the approval of the Landscape Architect at the Nursery and at the site. All trees shall have single leader unless otherwise noted. No unapproved substitutions will be accepted. Plants species and cultivar, size and quantity shall not change without the approval of the Landscape Architect.
- Location of all trees and shrubs shall be marked for the approval of the Landscape Architect the day prior to commencement of planting.
- 10. All plants shall bear the same relationship to finished grade as original grade before digging. Plants to be transplanted shall be carefully dug, with adequate root balls and surrounding soil and pruned according to ANA standard practices. Trees with root flare covered by more than 1 1/2" of soil will be rejected prior to installation. Set plants plumb.
- 11. All trees and shrubs shall be balled in burlap or containerized, unless otherwise noted. No root bound container grown stock will be accepted. All plastic root wrapping and metal wire baskets shall be carefully removed at the time planting. Wire directly under root ball can remain.
- 12 The planting soil mixture shall be a sandy loam modified with organic components of 4-8% organic matter, dry weight, PH range of 5.5 to 6.5 and no coarse fragments over 2". A soil sample from the proposed planting medium shall be sent to the UMass Extension Service, University of Massachusetts, West Experiment Station, Amherst, MA 01003, tel: 413.545.2311, fax: 413.545.1931 to be analyzed for organic matter, acidity, soluble salts, buffer PH, potassium and silt and clay content
- 13. Contractor shall place 3" of fine shredded dark brown, aged two years, pine bark mulch in all bed areas. Submit sample to Landscape Architect.
- 14. All evergreen plant material shall be sprayed in the first Fall after planting with an antidesiccant the first week of November.
- 15. Provide temporary irrigation system for all plant material. System to be functional for a spring and a fall planting season. Flood plants thoroughly once immediately after planting and twice during the first 24 hour period after planting.
- 16. Extreme care shall be taken not to disturb existing plant materials unless the plant is specifically noted to be transplanted or removed. Any plant injured, removed or destroyed without permission, shall be replaced with plant material of equal size and species at the Contractor's expense.
- 17. Do not wrap trunk of trees. 18. Stake only deciduous trees on windy exposures or steeper slopes. Evergreen trees may be
- staked at the discretion of the Landscape Architect. Consult with Landscape Architect. 19. Contractor shall maintain the trees for a minimum of 60 days following preliminary acceptance of Landscape Architect. After 6 days, provide Owner with written maintenance instructions.
- 20. Contractor shall guarantee all plant material for a minimum of one (1) year from the date of final acceptance of the Landscape Architect. The Contractor shall replace any dead or horticulturally damaged trees at his expense during the 1 year guarantee period.
- 21. Contractor shall provide Jute netting on steep slopes as directed by Civil Engineer to control soil erosion and loss.

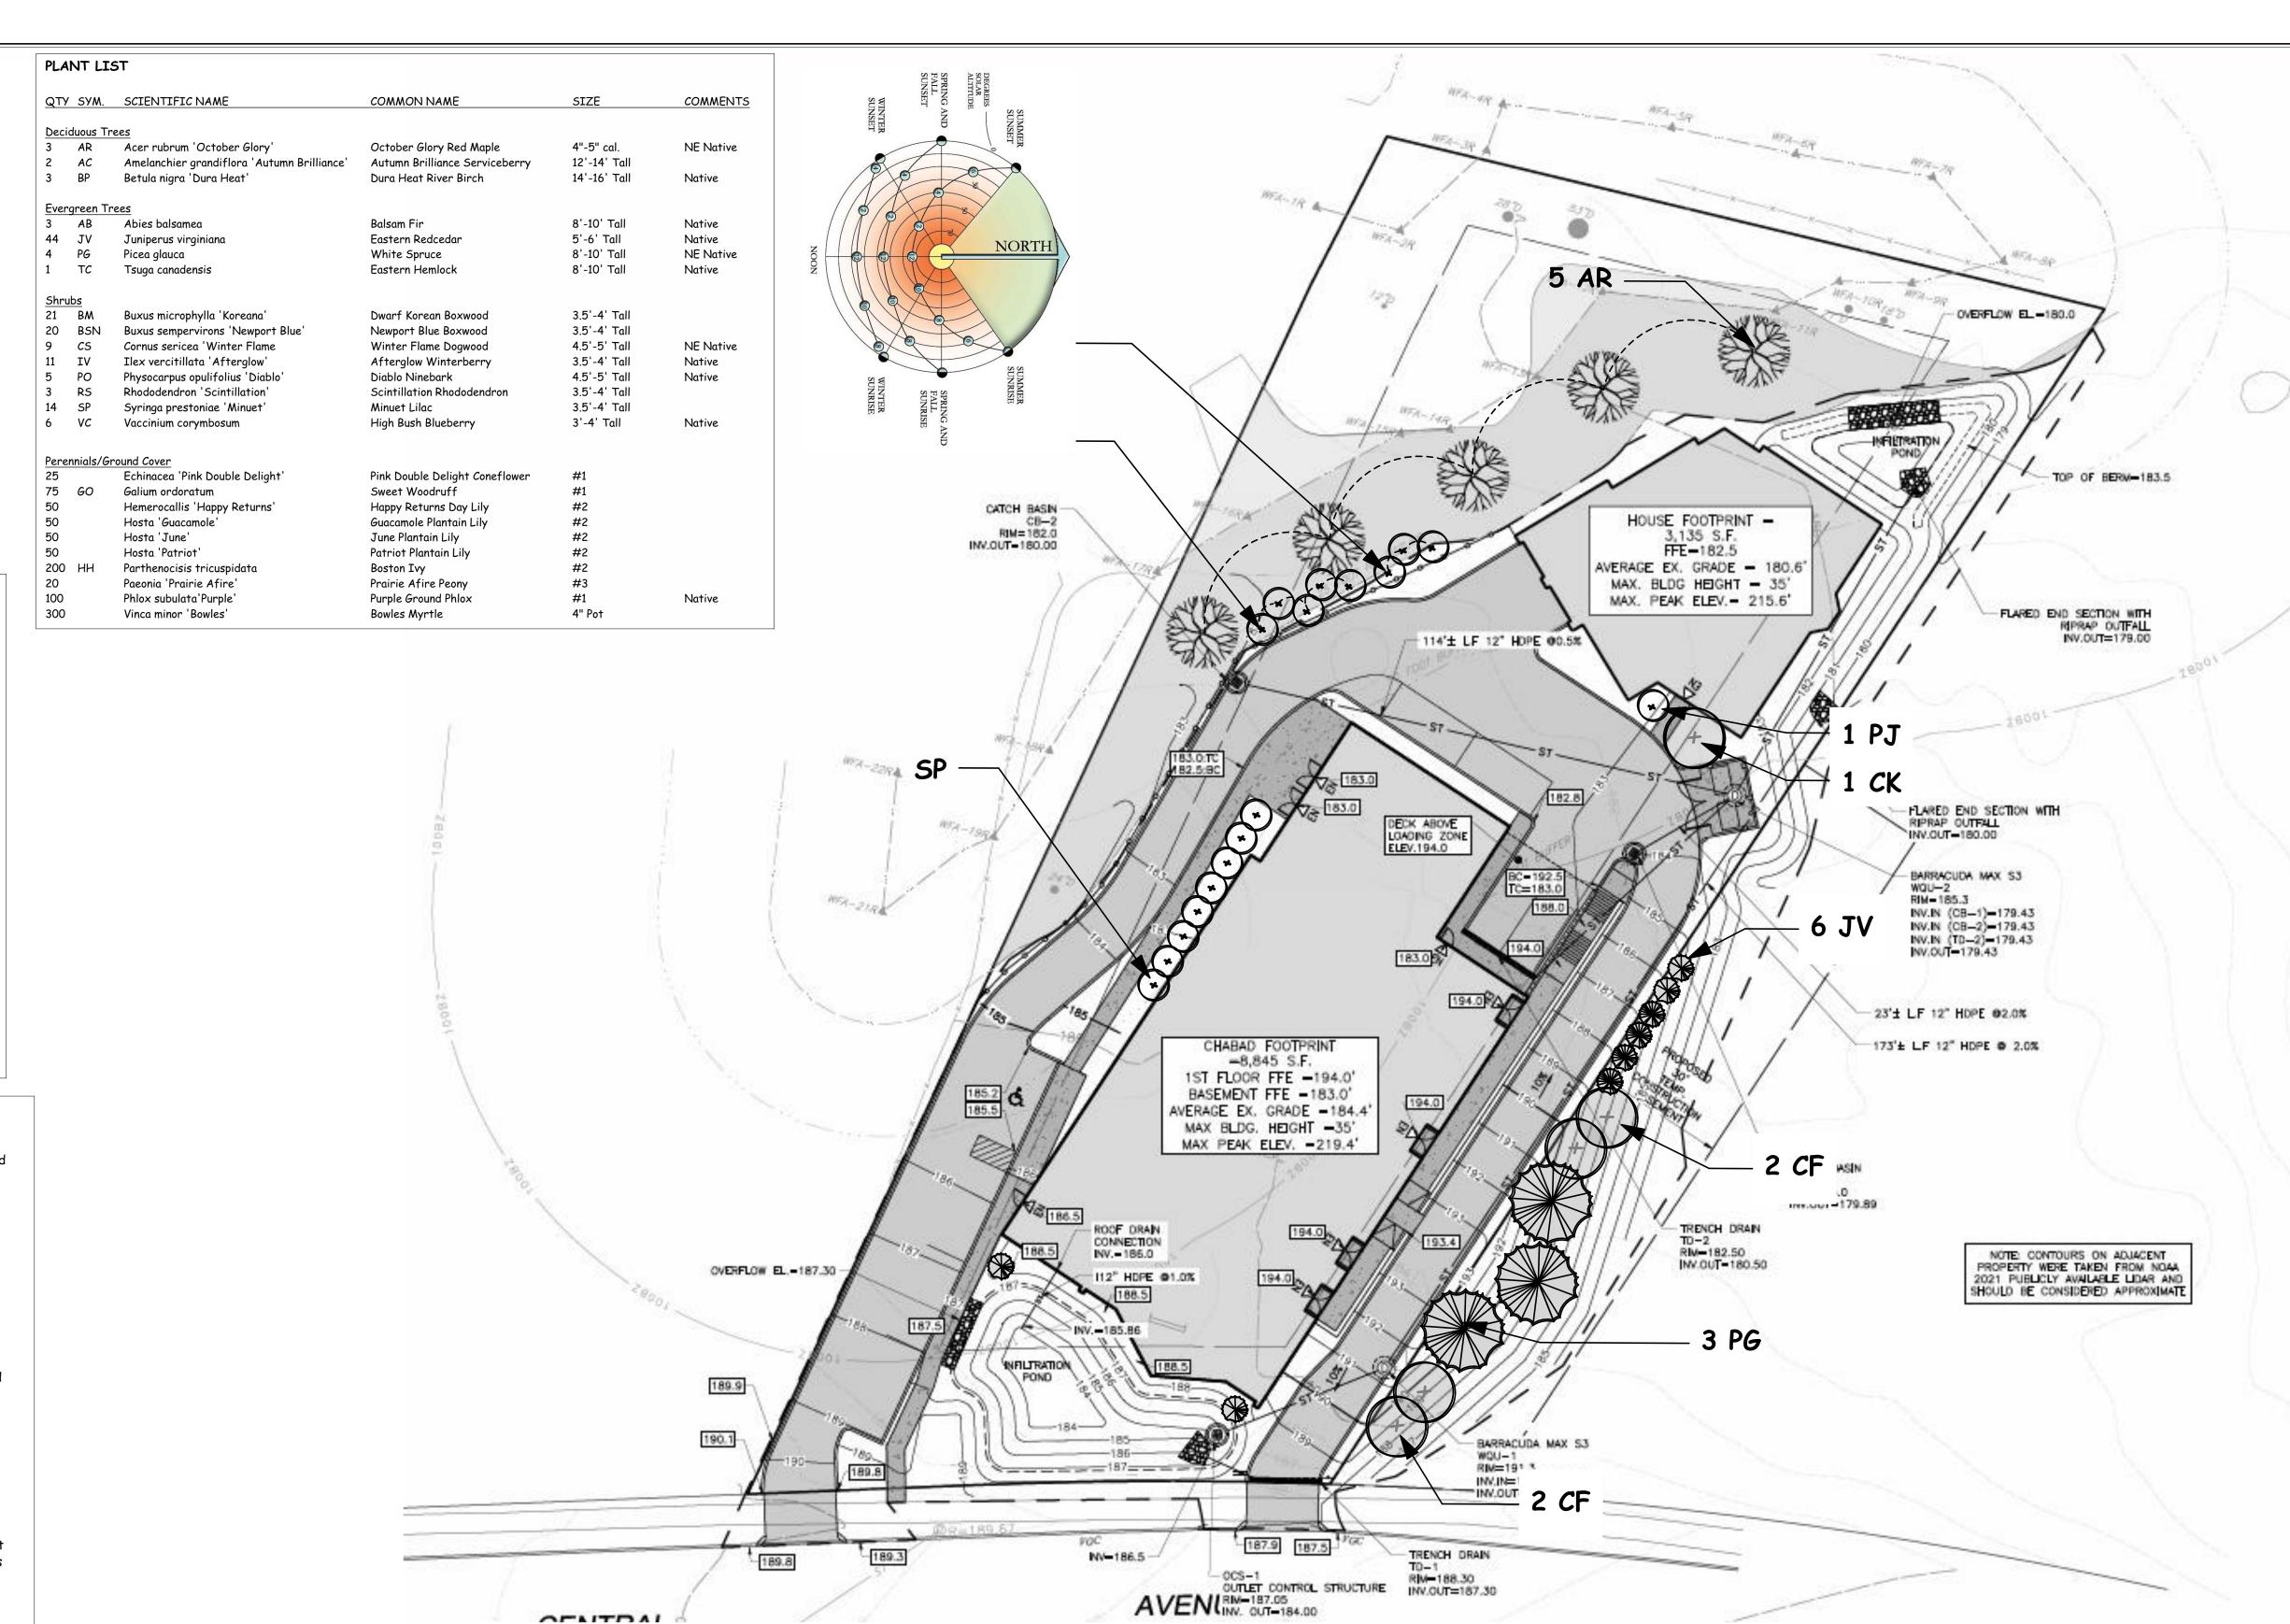

## Invasive Species Management Plan

## Invasive Shrubs

- 1) Winter: Treat all invasive shrubs with trunk penetrating herbicide during this winter. Use Dow Chemical Garlon 4 Ultra with a methylated seed oil carrier following the product label instructions. This formulation can be used effectively whenever the bark is dry and the temperature is near freezing
- 2) Spring: Wait until spring when treated plants are clearly "dead" for removal to ensure maximum translocation of the herbicide from the trunk to the root tissues. At this point the plants can be removed for disposal at an approved invasive plant material disposal site. Please note that spring ground conditions might delay removal operations. The ground is sufficiently firm to avoid unnecessary soil compaction. Use hand tools and only remove dead plants toavoid any species misidentification problems (native plants).
- 3) When weather and ground conditions permit a second basal bark application (Dow Chemical Garlon 4 Ultra with a methylated seed oil carrier following the product label instructions) will be made to any surviving target plants with sufficiently large bark area to be practical. This will include the intact plants that were missed in the first application and are "in leaf" and cut stumps that have significant
- 4) In combination with the basal bark application with suitable weather (dry and low wind) and ground conditions, begin foliar applications on small plants (knee height or less). This will include seedlings and also any sprouting clumps that produce a wide "floret". Foliar spray should be Garlon 4 Ultra mixed with water and applied with a backpack sprayer, again following label instructions. Note that most of these treated plants from the 2nd and 3rd applications can be left to decay in place.
- 5) Repeated foliar applications will be made at regular intervals as needed within the target area to bring invasive plant populations as close to zero as practical as soon as possible. This zero tolerance approach is the best way to minimize overall chemical use. Maintenance will be required every year.

## Landscape Water Use Management

New Installations of Trees, Shrubs, and Flowers

- 1. Provide temporary irrigation to all new plantings. Water with 2" of water to thoroughly soak the soils every day for two weeks following installation. 2. Thereafter, water at 1" two times per week to maintain a moist soil through the first summer into fall.
- 3. Water well one final time in late November before the ground freezes to improve the plant's ability to tolerate winter desiccation.

## New Installations of Conservation Seed and Wild Flower Mixes 1. Water with 2" of water (30 mins of aerial irrigation) to thoroughly soak

the soils every other day for two weeks following installation. Water at 1" two times per week to maintain a moist soil through the first summer into fall.

## Recommended Planting Seasons: Zone 5 and 6

Spring Planting	Season Begins	Season Ends	
Lawns	April 1-15	May 15-30	
Evergreens	April 1-15	May 15-30	
Deciduous Plants	April 1-15	May 15-30	
Fall Planting	Season Begins	Season Ends	
Lawns	August 1-15	September 15-30	
Evergreens	September 1-15	November 1-15	
Deciduous Plants	October 1-15	November 15-30	


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fisher design group Site Planning | Permitting | Landscape Architecture | Urban Desig

Scale: 07/21/2025 Date: 1"=20'


Sheet L-1.01

Landscape Plan



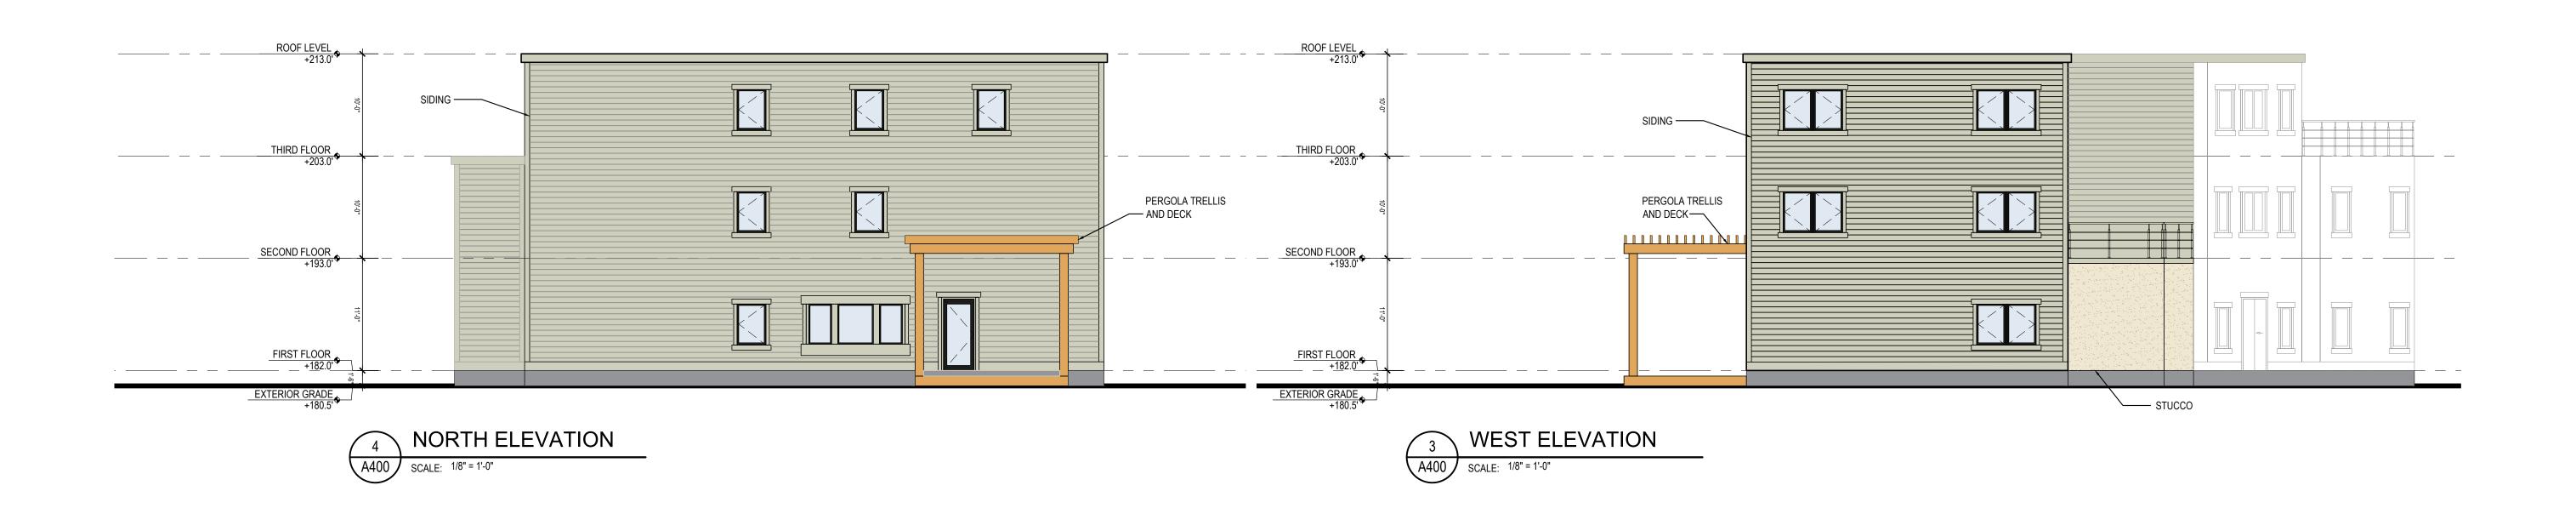



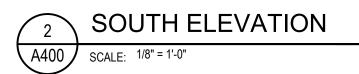



1749 CENTRAL STREET, SUITE 2 STOUGHTON, MA TEL:781.866.6973

22410

Project #:

NEEDHAM CHABAD 1195 CENTRAL AVENUE NEEDHAM, MA


ARCHITECTURAL REVIEW BOARD SUBMISSION

5	SUBMISSION				
Revision	ns:				
No.:	Issue:	Date:			
Scale:	AS NOTED				
Date:	Date: AUGUST 4, 2025				
Drawing Title:					

**EXTERIOR ELEVATIONS**: RESIDENCE

Sheet No.:




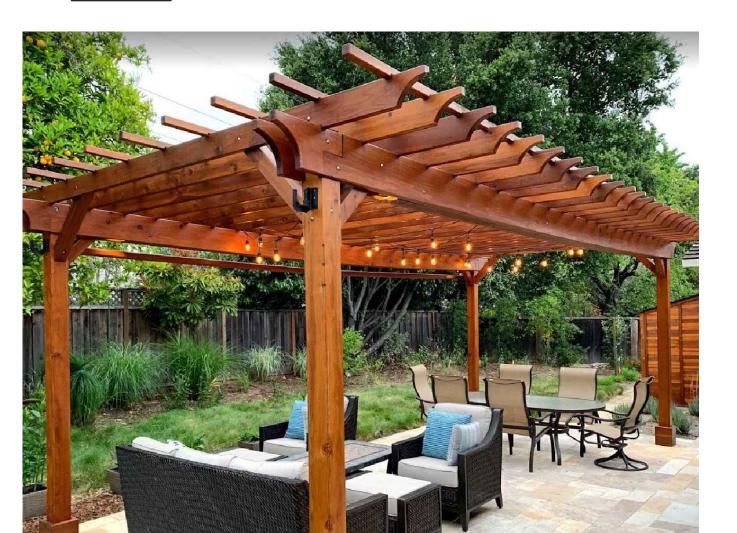

BLACK ALUMINUM STOREFRONT

BOLLARD (CHABAD)



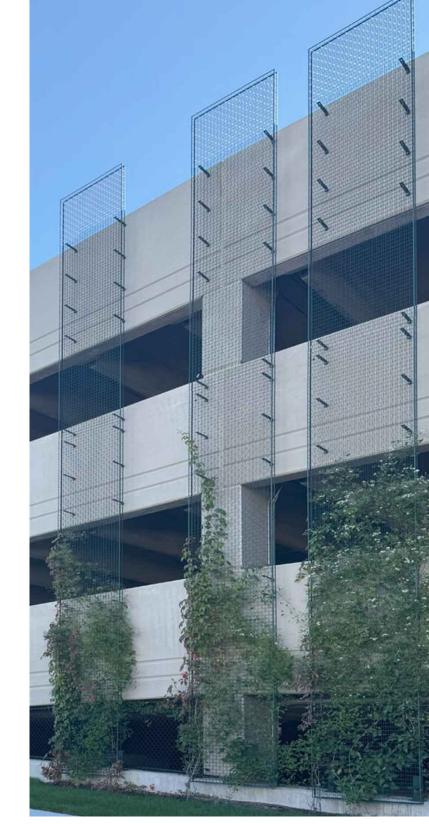

WALL TRELLIS (CHABAD)







WINDOW TINT (CHABAD)

SIDING (CHABAD AND RESIDENCE)

CHABAD PAINT COLOR SHERWIN WILLIAMS, STORM CLOUD

RESIDENCE PAINT COLOR SHERWIN WILLIAMS, ORIGAMI WHITE

EPDM RUBBER ROOFING

ALUMINUM COPING TO MATCH ADJACENT MATERIAL

EXTERIOR BUILDING MATERIALS

JERUSALEM STONE (CHABAD)



EXTERIOR WALL SCONCE



STUCCO (CHABAD AND RESIDENCE)



NEEDHAM CHABAD 1195 CENTRAL AVENUE NEEDHAM, MA

1749 CENTRAL STREET, SUITE 2 STOUGHTON, MA TEL:781.866.6973

22410

Project #:

ARCHITECTURAL REVIEW BOARD SUBMISSION

Revisio	ns:	
No.:	Issue:	Date:
Scale:	AS NOTED	

EXTERIOR MATERIALS BOARD

Date: AUGUST 4, 2025

Drawing Title:

Sheet No.:









**DECIDUOUS TREES** PERENNIALS/ GROUND COVER


EASTERN REDCEDAR





PATRIOT PLANTAIN LILY

**BOWLES MYRTLE** 

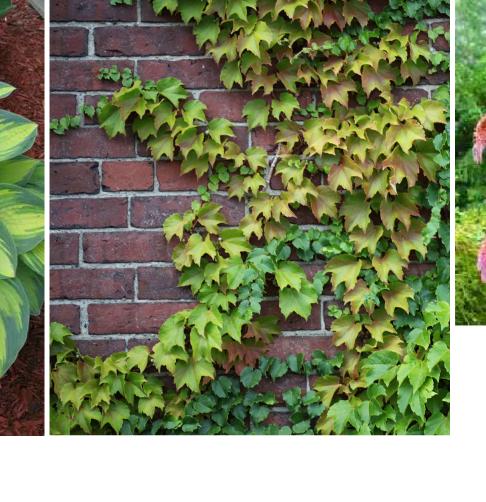

**BOSTON IVY** 



SWEET WOODRUFF



EASTERN HEMLOCK





PURPLE GROUND PHLOX

JUNE PLANTAIN LILY







BALSAM FIR

WHITE SPRUCE











1749 CENTRAL STREET, SUITE 2 STOUGHTON, MA TEL:781.866.6973

Project #: 22410

NEEDHAM CHABAD 1195 CENTRAL AVENUE NEEDHAM, MA

Revisions:

ARCHITECTURAL

REVIEW BOARD SUBMISSION

AS NOTED

Date: AUGUST 4, 2025

Drawing Title:

**EXTERIOR** LANDSCAPE BOARD



### TOWN OF NEEDHAM

### DESIGN REVIEW BOARD

Public Service Administration Building 500 Dedham Avenue Needham, MA 02492 **Application and Report** 

Address: 4500 Dorr Street Toledo OH 43618 Street City State Zip  Poplicant: Greystar Development East, LLC  Address: 1 Federal Street, Suite 1804 Boston MA 02110 Street City State Zip  Pelephone: (857) 254-1329  Pesigner/Installer: Cube3 Studio LLC	roperty 1	Location: 100 W	/est Street, Needhar	m, MA 02494	Date	. <u>8/28/25</u>
Street City State Zip  poplicant:  Greystar Development East, LLC  Street City State Zip  State Zip  Street City State Zip  stephone:  Gesty 254-1329   clephone:  City State Zip  clephone:  Greystar Development East, LLC  Street City State Zip  clephone:  Greystar Development East, LLC  Street City State Zip  clephone:  Greystar Development  Street City State Zip  clephone:  Greystar Development  State Zip  City State Zip  clephone:  Greystar Development  India Street North Andover MA O1845  Street City State Zip  clephone:  Greystar Development  India Street North Andover MA O1845  State Zip  clephone:  Greystar Development  India Street North Andover MA O1845  State Zip  clephone:  Greystar Development  India Street State State  India State  Ind	Owner:	HCRI Massac	hussetts Properties	Trust II		
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Address: 1 Federal Street, Suite 1804 Boston MA 02110  Street City State Zip  Resigner/Installer: Cube3 Studio LLC  Reddress: 56 High Street North Andover MA 01845  Street City State Zip  Relephone: (978) 989-9900    Type of Application   Sign   Minor Project   Exterior Alterations   Major Project (Site Plan Review)   Planned Residential Development   Planned Residential Development   Planned Residential Compound   Planned Residential Compound   Planned Residential Compound   Project (Site Plan Review)   Planned Residential Compound   Planned Residenti	elephone			•	Sittle	Ζιρ
Street City State Zip  esigner/Installer: Cube3 Studio LLC  ddress: 56 High Street North Andover MA 01845  Street City State Zip  elephone: (978) 989-9900    Type of Application   Sign   Major Project   Exterior Alterations   Major Project (Site Plan Review)   - preliminary   - final   Flexible Subdivision   Planned Residential Development   Residential Compound   Residential Compound   Interest   Residential Compound   Interest   Residential Compound   Interest   Inte	plicant.	Greystar Devel	opment East, LLC			
esigner/Installer:  Cube3 Studio LLC  ddress: 56 High Street North Andover MA 01845  Street City State Zip  elephone: (978) 989-9900  Type of Application Sign Minor Project Exterior Alterations Major Project (Site Plan Review) - preliminary - final Flexible Subdivision Planned Residential Development Residential Compound  rief description of sign or project: poosed redevelopment of the property by demolishing the existing building and constructing a three-story multifamiliding containing a total of 189 residential units and associated amenities (the "Project"). The Project also	ddress:	1 Federal Stree	et, Suite 1804	Boston	MA	02110
Address: 56 High Street	elephone			City	State	Zip
Street   City   State   Zip	esigner/l	Installer: Cube3	3 Studio LLC			
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				e existing building and constru	ıcting a three-s	story multifamil
cludes186 surface parking spaces	uilding cont	aining a total of 189	residential units and assoc	ciated amenities (the "Project"	'). The Project	also
ease email completed application to elitchman@needhamma.gov						



August 29, 2025

#### BY OVERNIGHT MAIL & ELECTRONIC MAIL

Town of Needham Design Review Board Members Public Service Administration Building 500 Dedham Avenue Needham, MA 02492

Attn: Mark Gluesing, Chair

Re: 100 West Street, Needham Heights, Massachusetts (the "Property")

Dear Design Review Board Members:

We are counsel to Greystar Development East, LLC (the "<u>Applicant</u>") in connection with the redevelopment of 100 West Street. The Applicant is proposing to redevelop the Property by demolishing the existing building and constructing a three-story multifamily residential building containing a total of 189 residential units and associated amenities (the "<u>Project</u>").

The Applicant filed an application for Site Plan Review for the Project on August 11, 2025. In anticipation of the Planning Board meeting scheduled for September 16, 2025, and pursuant to the Needham Zoning By-Law, enclosed is an Application for Design Review for the Project (the "Application"). In support of the Application, the Applicant is submitting the following materials and information (one large format hard copy of the Site Development Plan Set and the Architectural Plan Set will be mailed to the Planning and Community Development Department):

- 1. Design Review Board Application
- 2. Site Development Plan Set titled "Site Development Plans for Greystar Proposed Residential Development" prepared by Bohler Engineering, which includes the following, all dated August 12, 2025:
  - a. Sheet C-101 Cover Sheet
  - b. Sheet C-102 General Notes and Legend
  - c. Sheet C-301 Site Plan
  - d. Sheet C-401 Grading and Drainage Plan
  - e. Sheet C-501 Utility Plan
  - f. Sheet C-801 Erosion and Sediment Control Plan

- g. Sheet C-802 Erosion and Sediment Control Notes and Details
- h. Sheets C-901 and C-902 Construction Details
- i. Sheet L-100 Landscape Plan
- j. Sheet L-200 Lighting Plan
- k. Sheets L-300, L-301, and L-302 Landscape Details
- 3. Architectural Plan Set prepared by Cube 3 Studio LLC, which includes the following, all dated August 8, 2025:
  - a. Floor Plans
  - b. Building Elevations
  - c. Building Elevations and Sections
- 4. Existing Conditions Photographs Set

We appreciate your attention to this matter. The Applicant and the entire Project team look forward to meeting with you and discussing the Project on September 8, 2025.

Very truly yours,

/s/ Timothy Sullivan

Timothy W. Sullivan Attorney for Applicant

**Enclosures** 

FOR ——



**PROPOSED** 

# RESIDENTIAL DEVELOPMENT

**LOCATION OF SITE:** 


100 WEST STREET, TOWN OF NEEDHAM NORFOLK COUNTY, MASSACHUSETTS PARCEL ID: 199/063.0-0037-0000.0

## REFERENCES AND CONTACTS


◆ARCHITECTURAL PLAN: 56 HIGH STREET NORTH ANDOVER, MA 01845 DATED: 08/12/25 **GOVERNING AGENCIES** ♦PLANNING BOARD 1471 HIGHLAND AVENUE PHONE: (781) 455-7500 **♦BUILDING DEPARTMENT** 500 DEDHAM AVENUE PHONE: (781) 455-7550, EXT. 1 **♦FIRE DEPARTMENT** 88 CHESTNUT STREET PHONE: (781) 455-7580 FAX: (781) 444-2174 **ROW JURISDICTION** ♦TRAFFIC, STORMWATER, WATER & DEPARTMENT OF PUBLIC WORKS (DPW) 500 DEDHAM AVENUE PHONE: (781) 455-7550

THE ABOVE REFERENCED DOCUMENTS ARE INCORPORATED BY REFERENCE AS PART OF THESE PLANS, HOWEVER, BOHLER ENGINEERING DOES NOT CERTIFY THE ACCURACY OF THE WORK REFERENCED OR DERIVED FROM THESE DOCUMENTS, BY OTHERS.

T IS THE RESPONSIBILITY OF THE CONTRACTOR TO REVIEW ALL OF THE DRAWINGS AND SPECIFICATIONS ASSOCIATED WITH THIS PROJECT ORK SCOPE PRIOR TO THE INITIATION OF CONSTRUCTION, SHOULD THE CONTRACTOR FIND A CONFLICT WITH THE DOCUMENTS RELATIVE THE SPECIFICATIONS OR APPLICABLE CODES, IT IS THE CONTRACTOR'S RESPONSIBILITY TO NOTIFY THE PROJECT ENGINEER OF RECORD IN WRITING PRIOR TO THE START OF CONSTRUCTION. FAILURE BY THE CONTRACTOR TO NOTIFY THE PROJECT ENGINEER SHALL CONSTITUTE CCEPTANCE OF FULL RESPONSIBILITY BY THE CONTRACTOR TO COMPLETE THE SCOPE OF THE WORK AS DEFINED BY THE DRAWINGS AND IN

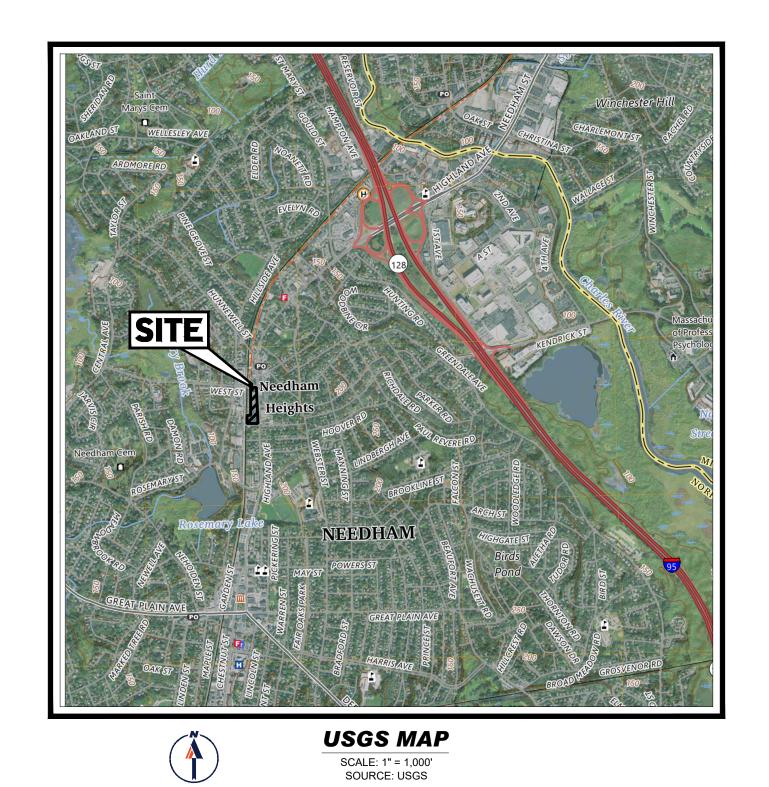



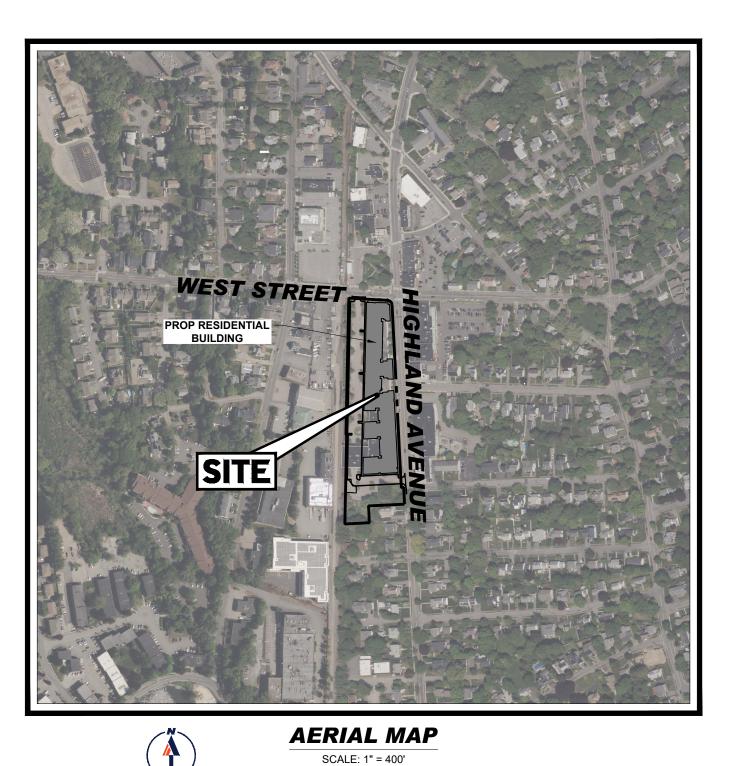

SOURCE: GOOGLE




PREPARED BY



CONTACT: ZACHARY RICHARDS, 617-849-8040

SITE DEVELOPMENT PLANS

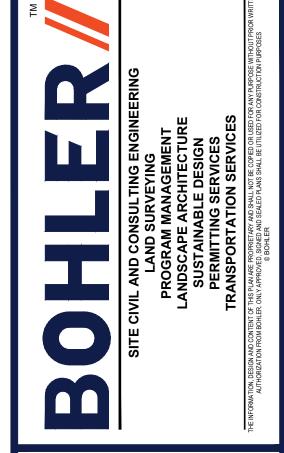

**REVISIONS** 

SHEET INDEX

SHEET NUMBER

C-102

C-301

C-401

C-501

C-801

C-802

C-901 - C-902

L-100

L-200

L-300 - L-302

1 SHEET

SHEET TITLE

GENERAL NOTES AND LEGEND

GRADING AND DRAINAGE PLAN

CONSTRUCTION DETAILS

LANDSCAPE PLAN

LANDSCAPE DETAILS

LIGHTING PLAN

**EROSION & SEDIMENT CONTROL PLAN** 

BOUNDARY, TOPOGRAPHIC & UTILITY SURVEY

EROSION AND SEDIMENT CONTROL NOTES AND DETAILS

REFERENCE PLANS

Call before you dig. **ALWAYS CALL 811** It's fast. It's free. It's the law.

**ENTITLEMENT SET** 

CHECKED BY: DATE:

**DEVELOPMENT PLANS** 

**G**REYSTAR

RESIDENTIAL DEVELOPMENT PARCEL ID: 199/063.0-0037-0000.0 **100 WEST STREET NORFOLK COUNTY** 

**TOWN OF NEEDHAM MASSACHUSETTS** 

45 FRANKLIN STREET, 5th FLOOR **BOSTON, MA 02110** Phone: (617) 849-8040

www.BohlerEngineering.com



COVER SHEET

			EQUIREMENTS	<u> </u>							
	ITEM  MIN PARKING STALL SIZE	<b>CODE</b> § 5.1.3 (f)	PERMITTED         EXIS           9 X 18.5 FT         9 X 1		X 18.5 FT		I	MF - AVERY SQUARE BUSIN USE: AFFORDABLE HOUSIN	NG	N/	-
	MIN COMPACT PARKING STALL SIZE  MIN PARALLEL PARKING STALL SIZE	§ 5.1.3 (e) § 5.1.3 (f)	8 X 16 FT		8 X 16 FT N/A	-	APPLICANT	GREYSTAR DEVELOPME	ENT EAST, LLC	N	
	MIN AISLE WIDTH (90 DEG STALLS)	§ 5.1.3 (i)	24 FT 24	T±	24 FT	APPLICANT:		ONE FEDERAL STREET S BOSTON, MA 02110  HCRI MASSACHUSETTS I	SUITE 1804		1
	MIN AISLE WIDTH (PARALLEL STALLS MIN SIDE YARD PARKING SETBACK	§ 5.1.3 (i) § 5.1.3 (j)	12 FT N 8	A T±	N/A 6 FT ±	PROPERTY OWNER:		4500 DORR ST TOLEDO, OH 43615	PROPERTIES TRUST II		<u></u> │ │ <b>┡</b> ┷
	MIN FRONT YARD PARKING SETBACE PARKING COUNT	§ 5.1.3 (j) § 5.1.4	10 FT 13 189 1		10 FT 186 (W)		BULK	K REQUIREM	т т		]  🕳
NAD83	MAX COMPACT PARKING STALLS	§ 5.1.3 (i)	50% OF TOTAL	A 93 SF	PACES (50%)	ITEM MIN LOT AREA	<b>CODE</b> § 3.17.5.1	PERMITTED  10,000 SF	<b>EXISTING</b> 187,219 SF ±	PROPOSED  NO CHANGE	-    <b></b>
	BICYCLE SPACES  KEY (V) VARIANCE	§ 3.17.6 (f)	189 N	Α	109	MIN LOT FRONTAGE  MIN FRONT YARD SETBACK	§ 3.17.5.1 § 3.17.5.1	80 FT 10 FT	1,000 FT ± 9.1 FT (E)	NO CHANGE  10.9 FT	<b>∄  →</b>
	(W) WAIVER  MULTI-FAMILY RESIDENTIAL					MAX FRONT YARD SETBACK	§ 3.17.5.1	15 FT <sup>A</sup>	67 FT (E)	70.7% AT <15 FT	1 <b>(</b>
	REQUIRED CAR SPACES= 1 SPACES 189 UNITS * 1 = 189 SPACES					MIN SIDE YARD SETBACK MIN REAR YARD SETBACK	§ 3.17.5.1 § 3.17.5.1	10 FT <sup>B,C</sup> 20 FT <sup>B,C</sup>	0 FT (E) N/A	11.2 FT 70.2	
	REQUIRED BICYCLE SPACES: 1 BICYCLE 189 DWELLING UNITS = 198 BICYCLE					MAX PERMITTED HEIGHT (STORIES  MAX PERMITTED HEIGHT (FEET) <sup>E,F</sup>	§ 3.17.5.2 § 3.17.5.2	3 <sup>D</sup>	3 30.8 FT	3 <40 FT	
	QUANTI	TV OVMBOL	PARKING LE	END		FLOOR AREA RATIO (FAR)	§ 3.17.5.3	1.3 <sup>G,H</sup>	0.34	1.09	<b> </b>
	QUANTIT	TY SYMBOL	TYPE PARKING SPACE		<b>SIZE</b> 9' X 18.5'	MAX BUILDING COVERAGE (%)  MAX DWELLING UNITS PER ACRE	§ 3.17.5.3 § 3.17.5.3	N/A 44 <sup>J</sup>	N/A N/A	N/A 43.97 DWELLING UNITS PER ACRE	
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	50	XX	SEMI-COMPACT PARKING	SPACES	8' X 18.5'	THE APPLICANT MAY APPLY FOR A	R OTHER SIMILAR SITE D SPECIAL PERMIT FROM	DESIGN FEATURES THAT EI M THE PLANNING BOARD IF	NHANCE THE STREETSC	BY COURTYARDS, LANDSCAPING, APE. IN THE ASB-MF SUBDISTRICT, RCENT (70%) OF THE MAIN DATUM	,
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						APPROPRIATELY INTEGRATED INTO THE INSTALLATIONS SHALL NOT PR	O THE ARCHITECTURE O	OF THE BUILDING AND THE	LAYOUT OF THE SITE.	SE OR SHADOW, AND MUST BE	
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						BUILDING(S), AND SHALL ALLOW NO INCIDENTAL TO THE OPERATION O	O VIEW OF PARKED VEH	HICLES FROM HIGHLAND AV	VENUE EXCÉPT WHERE S	UCH VIEW IS INTERMITTENT AND	
						THE TOTAL LAND AREA USED IN CALOCATED.	ALCULATING DENSITY SI	SHALL BE THE TOTAL ACRE	AGE OF THE LOT ON WH	CH THE DEVELOPMENT IS	
$rac{R=173.70'}{R=0.165.6'}$						JIN THE ASB-MF SUBDISTRICT, MUL	TI-FAMILY HOUSING MA	AY EXCEED THE MAXIMUM (	OF 44 DWELLING UNITS F	ER ACRE BY SPECIAL PERMIT.	<b>-</b>
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THE PART OF THE PA	PROP LOADING AND TRASH PICK-UP AREA  3-STORY AL BUILDING	19 450.4'	100 LOB 18.5; SPACS E 17.5; 18		ROUGHT—FON	8' F 1 N S 1	REBAR W/ CAP  REBAR W/ CAP  REBAR W/ CAP  15  15  17  180  180  180  180  180  180  180	SET LOD	CURB CUTS / WITHIN R.O.W. (TYP.)  UP#18/11A  9"TREE  R=178.55'  =170.6' 12"D  CONC. WALL	WEST STREET (PUBLIC - 50' WIDE)	lt's fa
TROP COLOCING FOR STORING TO SERVICE FOR STORING TO SERVICE FOR STORING TO SERVICE FOR SER	PROP LOADING AND TRASH PICK-UP AREA  3-STORY AL BUILDING	TENCE  W OF PINES  19  450.4'	18.5 PACS E 17.1 18.5 P		SPACES  WROUGHT—NOW  SPACES  HAR	8' F 1 N S 1	RISER 10 1 13.5	SET LOD	CURB CUTS / WITHIN R.O.W. (TYP.)  UP#18/11A  9"TREE  R=178.55'  =170.6' 12"D  CONC. WALL	LAIN  WEST STREET  (PUBLIC - 50' MIDE)	THIS DRAWING REVIEW AND APPI DOCUI  PROJECT NO DRAWN BY: CHECKED B DATE: CAD I.D.:  PROJECT:
THE PART OF THE PA	PROP LOADING AND TRASH PICK-UP AREA  3-STORY AL BUILDING	TENCE  W OF PINES  109  199  A50.4'	185 PAALES E 173 185 185 185 185 185 185 185 185 185 185		SPACES  WROUGHT—NOW  SPACES  WROUGHT—NOW  SPACES	8' F 1 N S 1	REBAR W/ CAP  REBAR W/ CAP  REBAR W/ CAP  15  15  17  180  180  180  180  180  180  180	SET)  OD LOD  LOD  LOD  LOD  LOD  LOD  LOD	CURB CUTS / WITHIN R.O.W. (TYP.)  UP#18/11A  9"TREE  R=178.55'  =170.6' 12"D  CONC. WALL	MEST STREET (PUBLIC - 50" MIDE)	ENT  THIS DRAWING REVIEW AND APPI DOCUI  PROJECT NO DRAWN BY: CHECKED B DATE: CAD I.D.:  PROJECT:  PROJECT:  PROJECT:
STATE OF THE STATE	PROP LOADING AND TRASH PICK-UP AREA  3-STORY AL BUILDING	TENCE  W OF PINES  109  199  450.4'	198 - 198 -		SPACES  WROUGHT - PAN  SPACES  101  1.0 CORN	8' F 1 N S 1	REBAR W/ CAP	SET)  OD LOD  LOD  LOD  LOD  LOD  LOD  LOD	CURB CUTS / WITHIN R.O.W. (TYP.)  UP#18/11A  9"TREE  R=178.55'  =170.6' 12"D  CONC. WALL	WEST STREET  (PUBLIC - 50' WIDE)	ENT  THIS DRAWING REVIEW AND APPI DOCUI  PROJECT NO DRAWN BY: CHECKED B DATE: CAD I.D.:  PROJECT:  PROJECT:  PROJECT:
STATE OF THE STATE	PROP LOADING AND TRASH PICK-UP AREA  3-STORY AL BUILDING	19 450.4'	100 100 100 100 100 100 100 100 100 100		SPACES  WROUGHT—PAN  SPACES  1.0' ECORN  1.0' ECORN	8' F 1 N S 1	REBAR W/ CAP  REBAR W/ CAP  STOP  13.57  RISER 0.0  RIS	OCATE  SETBACK  OUT  LOD  LOD  LOD  LOD  LOD  LOD  LOD  LO	CURB CUTS / WITHIN R.O.W. (TYP.)  UP#18/11A  9"TREE  R=178.55'  =170.6' 12"D  CONC. WALL	MEST STREET (PUBLIC - 50" WIDE)	ENT  THIS DRAWING REVIEW AND APPI DOCUM  PROJECT NO DRAWN BY: CHECKED B DATE: CAD I.D.:  PROJECT:  PROJECT:  PROJECT:  A B B B B B B B B B B B B B B B B B B
STATE OF THE STATE	PROP LOADING AND TRASH PICK-UP AREA  3-STORY AL BUILDING	19 450.4'	18.5° Add E		SPACES  WROUGHT - FON  SPACES  10'10'N  10'N	8' F 1 N S 1	REBAR W/ CAP  REBAR W/ CAP  TO THE CAP  TO	OCATE  SETBACK  OD  LOD  LOD  LOD  LOD  LOD  LOD  LOD	CURB CUTS / WITHIN R.O.W. (TYP.)  UP#18/11A  9"TREE  R=178.55'  =170.6' 12"D  CONC. WALL	MEST STREET (PUBLIC - 50" MIDE)	ENT  THIS DRAWING REVIEW AND APPI DOCUM  PROJECT NO DRAWN BY: CHECKED B DATE: CAD I.D.:  PROJECT:  PROJECT:  PROJECT:  A B B B B B B B B B B B B B B B B B B
FOR THE PARTY OF T	PROP LOADING AND TRASH PICK-UP AREA  3-STORY AL BUILDING	TO THE STATE OF TH	157.8°		SPACES  WROUGHT - TOWN  SPACES  10'N  10'N  10'N	8' F 1 N S 1	REBAR W/ CAP  REBAR W/ CAP  REBAR W/ CAP  15  15  17  180  180  180  180  180  180  180	SETBACK  OD  LOD  LOD  LOD  LOD  LOD  LOD  LOD	CURB CUTS / WITHIN R.O.W. (TYP.)  UP#18/11A  9"TREE  R=178.55'  =170.6' 12"D  CONC. WALL	WEST STREET  (PUBLIC - 50' WIDE)	ENT  THIS DRAWING REVIEW AND APPI DOCUI  PROJECT NO DRAWN BY: CHECKED B DATE: CAD I.D.:  PROJECT:  PROJECT:  ABO  THIS DRAWING REVIEW AND APPI DOCUI  PROJECT NO DRAWN BY: CHECKED B DATE: CAD I.D.:  PROJECT:  ABO  THIS DRAWING REVIEW AND APPI DOCUITE TO THE PROJECT IN THE PROJ
FOR THE PARTY OF T	PROP LOADING AND TRASH PICK-UP AREA  3-STORY AL BUILDING	19 450.4'	1578 F SIDE CONCRETE SIDE	10B 9 1 2 2 2 2 2 2 2 2 2 2 2 2 2 2 2 2 2 2	SPACES  WROUGHT - FON  SPACES  1.0 CORN  1.0 CORN  1.0 CORN  1.0 TO N	RUB  OLU  RUB  NCE  SUM  WCE  F  T  T  MAILBOX  RABOX  RAB	REBAR W/ CAP  REBAR W/ CAP  REBAR W/ CAP  15  15  15  17  180  17  180  17  180  17  180  17  180  17  180  180	OD LOD LOD LOD LOD LOD LOD LOD LOD LOD L	CURB CUTS / WITHIN R.O.W. (TYP.)  UP#18/11A  9"TREE  R=178.55'  =170.6' 12"D  CONC. WALL	WEST STREET  (PUBLIC - 50' WIDE)	ENT  THIS DRAWING REVIEW AND APPI DOCUM  PROJECT NO DRAWN BY: CHECKED B DATE: CAD I.D.:  PROJECT:  DE  RESID PARCEL  A5 FRAME  P
FOR THE PARTY OF T	PROP LOADING AND TRASH PICK-UP AREA  3-STORY AL BUILDING	19 (19) (19) (19) (19) (19) (19) (19) (1	100 1 100 100 100 100 100 100 100 100 1		SPACES  WROUGHT - PAN  SPACES  107  107  107  107  107  107  107  10	8 FE	74.4'	SET NO SE	CURB CUTS / WITHIN R.O.W. (TYP.)  UP#18/11A  9"TREE  R=178.55'  =170.6' 12"D  CONC. WALL W/WROUGHT IRON  6"TREE  UP W/2 RISERS & TRANS.  WATER FOUN!  8"TREE	WEST STREET (PUBLIC - 50' WIDE)	ENT  THIS DRAWING REVIEW AND APPI DOCUI  PROJECT NO DRAWN BY: CHECKED B DATE: CAD I.D.:  PROJECT:  PROJECT:  ABO  THIS DRAWING REVIEW AND APPI DOCUI  PROJECT NO DRAWN BY: CHECKED B DATE: CAD I.D.:  PROJECT:  ABO  THIS DRAWING REVIEW AND APPI DOCUITE TO THE PROJECT IN THE PROJ
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FIGURE 100 CONTROL OF THE STATE	PROP LOADING AND TRASH PICK-UP AREA  3-STORY AL BUILDING	19 450.4'	100 100 100 100 100 100 100 100 100 100		SPACES  WROUGHT—FON  SPACES  1.0 CORN  1.0 COR	8 FE	74.4'	SET LOD	CURB CUTS / WITHIN R.O.W. (TYP.)  UP#18/11A  9"TREE  R=178.55'  =170.6' 12"D  CONC. WALL W/WROUGHT IRON  6"TREE  UP W/2 RISERS & TRANS.  WATER FOUN!  8"TREE	MEST STREET  (PUBLIC - 50' WIDE)	ENT  THIS DRAWING REVIEW AND APPI DOCUM  PROJECT NO DRAWN BY: CHECKED B DATE: CAD I.D.:  PROJECT:  DE  RESID PARCEL  A5 FRAME  P
FIGURE 100 CONTROL OF THE STATE	PROP LOADING AND TRASH PICK-UP AREA  3-STORY AL BUILDING	19 450.4'	24 R=173  1578  CONCRETE SIDE		SPACES  WROUGHT - FON  SPACES  1.0 CORN  1.0 C	8 FE	74.4'	SETELL POLE	CURB CUTS / WITHIN R.O.W. (TYP.)  UP#18/11A  9"TREE  R=178.55'  =170.6' 12"D  CONC. WALL W/WROUGHT IRON  6"TREE  UP W/2 RISERS & TRANS.  WATER FOUN!  8"TREE	WEST STREET  (PUBLIC - 50' WIDE)	RESID PARCEL  RESID PARCEL  WWW.B
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FIGURE 100 CONTROL OF THE STATE	PROPLOADING AND TRASH PICK-UP AREA  3-STORY AL BUILDING FOOTPRINT AL UNITS  47.6  47.6  47.6  47.6  47.6  47.6	TOWN TO W	185 24 8 = 173 185 27		SPACES  WROUGHT—PAN  SPACES  WROUGHT—PAN  10'W  10'W  10'W	8 FE	74.4'	SETBACK SETBACK  SOLUTION  10' FRONT YAR SETBACK  8'STEEL  POLE	CURB CUTS / WITHIN R.O.W. (TYP.)  UP#18/11A  9"TREE  R=178.55'  =170.6' 12"D  CONC. WALL W/WROUGHT IRON  6"TREE  UP W/2 RISERS & TRANS.  WATER FOUN!  8"TREE	MEST STREET  (PUBLIC - 50' MIDE)	THIS DRAWIN REVIEW AND AP DOC PROJECT IN DRAWN BY CHECKED DATE: CAD I.D.:  PROJECT:  DE  RESI PARCE  45 FRAME  WWW.
FIGURE 100 CONTROL OF THE STATE	PROPLOADING AND TRASH PICK-UP AREA  3-STORY AL BUILDING FOOTPRINT AL UNITS  47.6  47.6  47.6  47.6  47.6  47.6	19 450.4'	1885 24 99 R=173 1885 100 100 100 100 100 100 100 100 100 10		SPACES  WROUGHT—FAN  SPACES  1.0' CORN  1.0'	8 FE	74.4'	SETHACK  STBACK  OD  LOD  LOD  SOLUTION  STREEL  POLE	CURB CUTS / WITHIN R.O.W. (TYP.)  UP#18/11A  9"TREE  R=178.55'  =170.6' 12"D  CONC. WALL W/WROUGHT IRON  6"TREE  UP W/2 RISERS & TRANS.  WATER FOUN!  8"TREE	WEST STREET (PUBLIC - 50' WIDE)	THIS DRAWIN REVIEW AND AP DOC PROJECT IN DRAWN BY CHECKED DATE: CAD I.D.:  PROJECT:  DE  RESI PARCE  45 FRAME  WWW.
ATT A STOLL OF THE PROPERTY OF	PROPLOADING AND TRASH PICK-UP AREA  3-STORY AL BUILDING FOOTPRINT AL UNITS  47.6  47.6  47.6  47.6  47.6  47.6	450.4'	157.8°  CONCRETE SIDE		SPACES  WROUGHT—FON  SPACES  1.0° CORN  1.0°	8 FE	74.4'	SETHACK  10 FRONT YAR SETBACK  10 FRONT YAR	CURB CUTS / WITHIN R.O.W. (TYP.)  UP#18/11A  9"TREE  R=178.55'  =170.6' 12"D  CONC. WALL W/WROUGHT IRON  6"TREE  UP W/2 RISERS & TRANS.  WATER FOUN!  8"TREE	WEST STREET  (PUBLIC - 50" WIDE)	RESIL PARCE  SHEET TITL
FIGURE 100 CONTROL OF THE STATE	PROPLOADING AND TRASH PICK-UP AREA  3-STORY AL BUILDING FOOTPRINT AL UNITS  47.6  47.6  47.6  47.6  47.6  47.6	TOWN TO WILL TO THE STATE OF TH	150 LOO 157.8°		SPACES  WROUGHT—FON  SPACES  1.0 CORN  1.0 CORN  1.0 CORN  1.5 D  1.5 D  1.5 D  1.5 D	8 FE	74.4'	SETBACK SETBACK STBACK POLE	CURB CUTS / WITHIN R.O.W. (TYP.)  UP#18/11A  9"TREE  R=178.55'  =170.6' 12"D  CONC. WALL W/WROUGHT IRON  6"TREE  UP W/2 RISERS & TRANS.  WATER FOUN!  8"TREE	MEST STREET  (PUBLIC - 50' WIDE)	RESIDENT  REVIEW AND APP DOCU  PROJECT N DRAWN BY: CHECKED E DATE: CAD I.D.:  PROJECT:  BC  45 FRAM  WWW.E
FIGURE 100 CONTROL OF THE STATE	PROPLOADING AND TRASH PICK-UP AREA  3-STORY AL BUILDING FOOTPRINT AL UNITS  47.6  47.6  47.6  47.6  47.6  47.6	19 450.4'	1885 1885 1885 1885 1885 1885 1885 1885		SPACES  WROUGHT—HOW  SPACES  1.0 CORN  1.0 COR	8 FE	774.4'	B'STEEL POLE  THIS PLAN	CURB CUTS / WITHIN R.O.W. (TYP.)  ### 178.55' ### 170.6' ### 12"D ### CONC. WALL ### WATER FOUNT ### 10"W  ### 10"W  ### 10"W  ### 10"W  ### 10"W  ### 10"W	JZED FOR	RESIDENT TO SHEET TITLES SEED TO SHEET TITLES SEED TO
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FIGURE 100 CONTROL OF THE STATE	PROPLOADING AND TRASH PICK-UP AREA  3-STORY AL BUILDING FOOTPRINT AL UNITS  47.6  47.6  47.6  47.6  47.6	450.4'	185 Part of the state of the st		A GOVERNOUS HIT TO THE SPACE OF	8 FE	774.4'	THIS PLAN SITE LAYO	CURB CUTS / WITHIN R.O.W. (TYP.)  ### 178.55' ### 170.6' ### 12"D ### CONC. WALL ### WATER FOUNT ### 10"W  ### 10"W  ### 10"W  ### 10"W  ### 10"W  ### 10"W	JZED FOR	RESIDENT TO SHEET TITLE

PARKING REQUIREMENTS

**ZONING TABLE** 

REVISIONS

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MAB250036.00
JGM/DST/CA
AMB/JE
08/12/2025
P-CIVL-SITE

SITE VELOPMENT **PLANS** 

GREYSTAR

PROPOSED ENTIAL DEVELOPMENT

ID: 199/063.0-0037-0000.0 DO WEST STREET ORFOLK COUNTY DWN OF NEEDHAM MASSACHUSETTS


KLIN STREET, 5th FLOOR SOSTON, MA 02110 hone: (617) 849-8040


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 MAB250036.

 DRAWN BY:
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 AMB/C

 DATE:
 08/12/20

 CAD I.D.:
 P-CIVL-SI

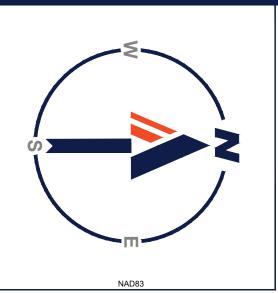SITE
DEVELOPMENT
PLANS

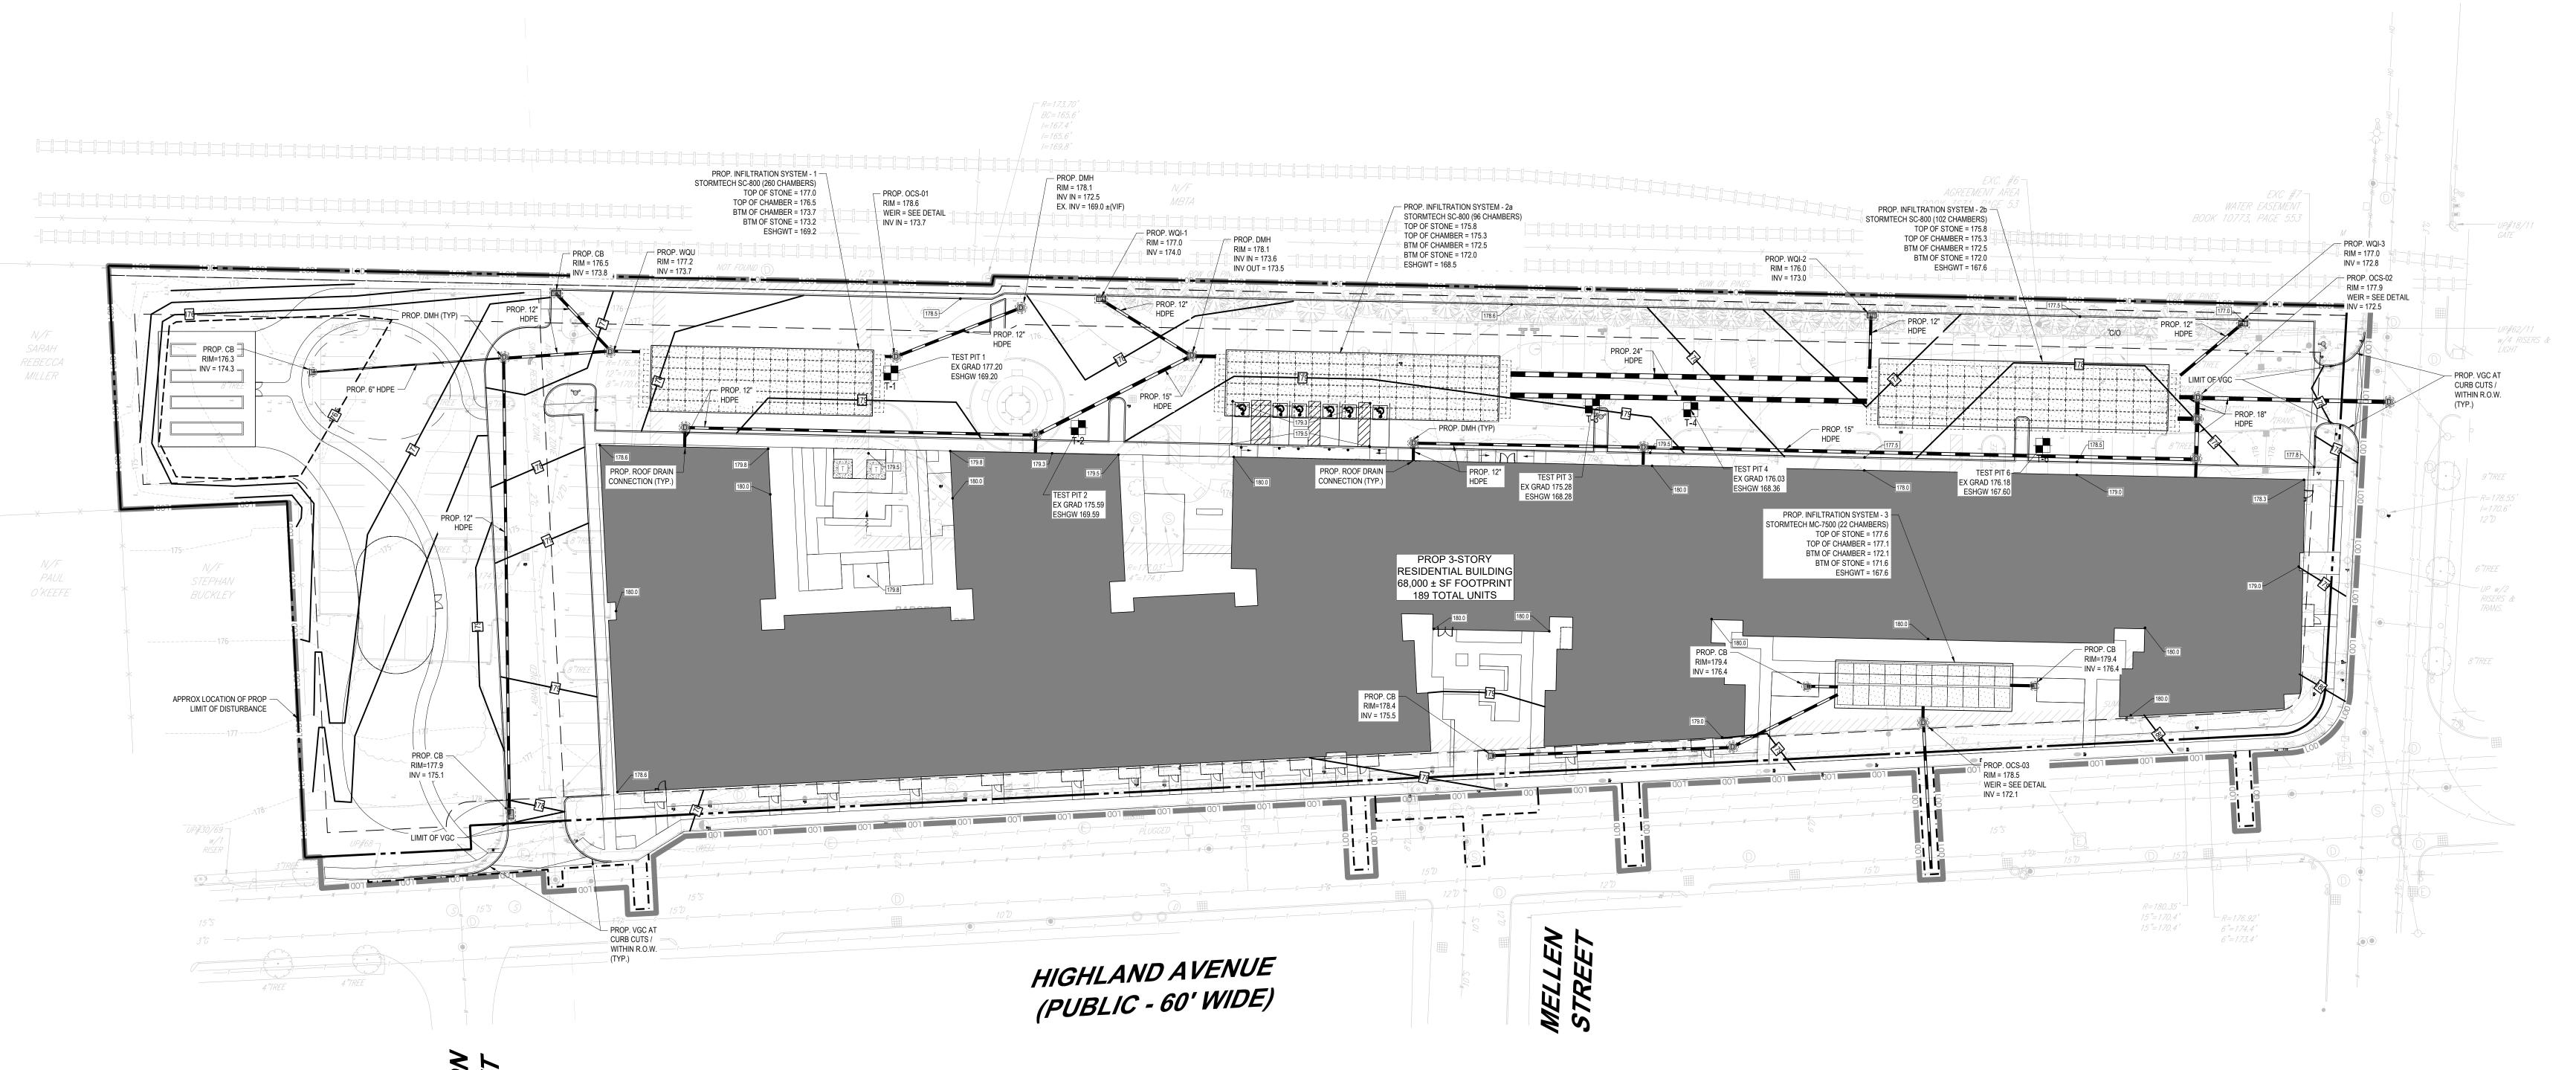GREYSTAR

PROPOSED
RESIDENTIAL DEVELOPMENT

PARCEL ID: 199/063.0-0037-0000.0 100 WEST STREET NORFOLK COUNTY TOWN OF NEEDHAM MASSACHUSETTS

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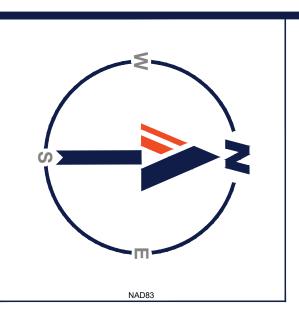
THIS PLAN TO BE UTILIZED FOR GRADING AND DRAINAGE


**PURPOSES ONLY** 

GRADING AND DRAINAGE PLAN

C-401

ORG. DATE - 08/12/2025



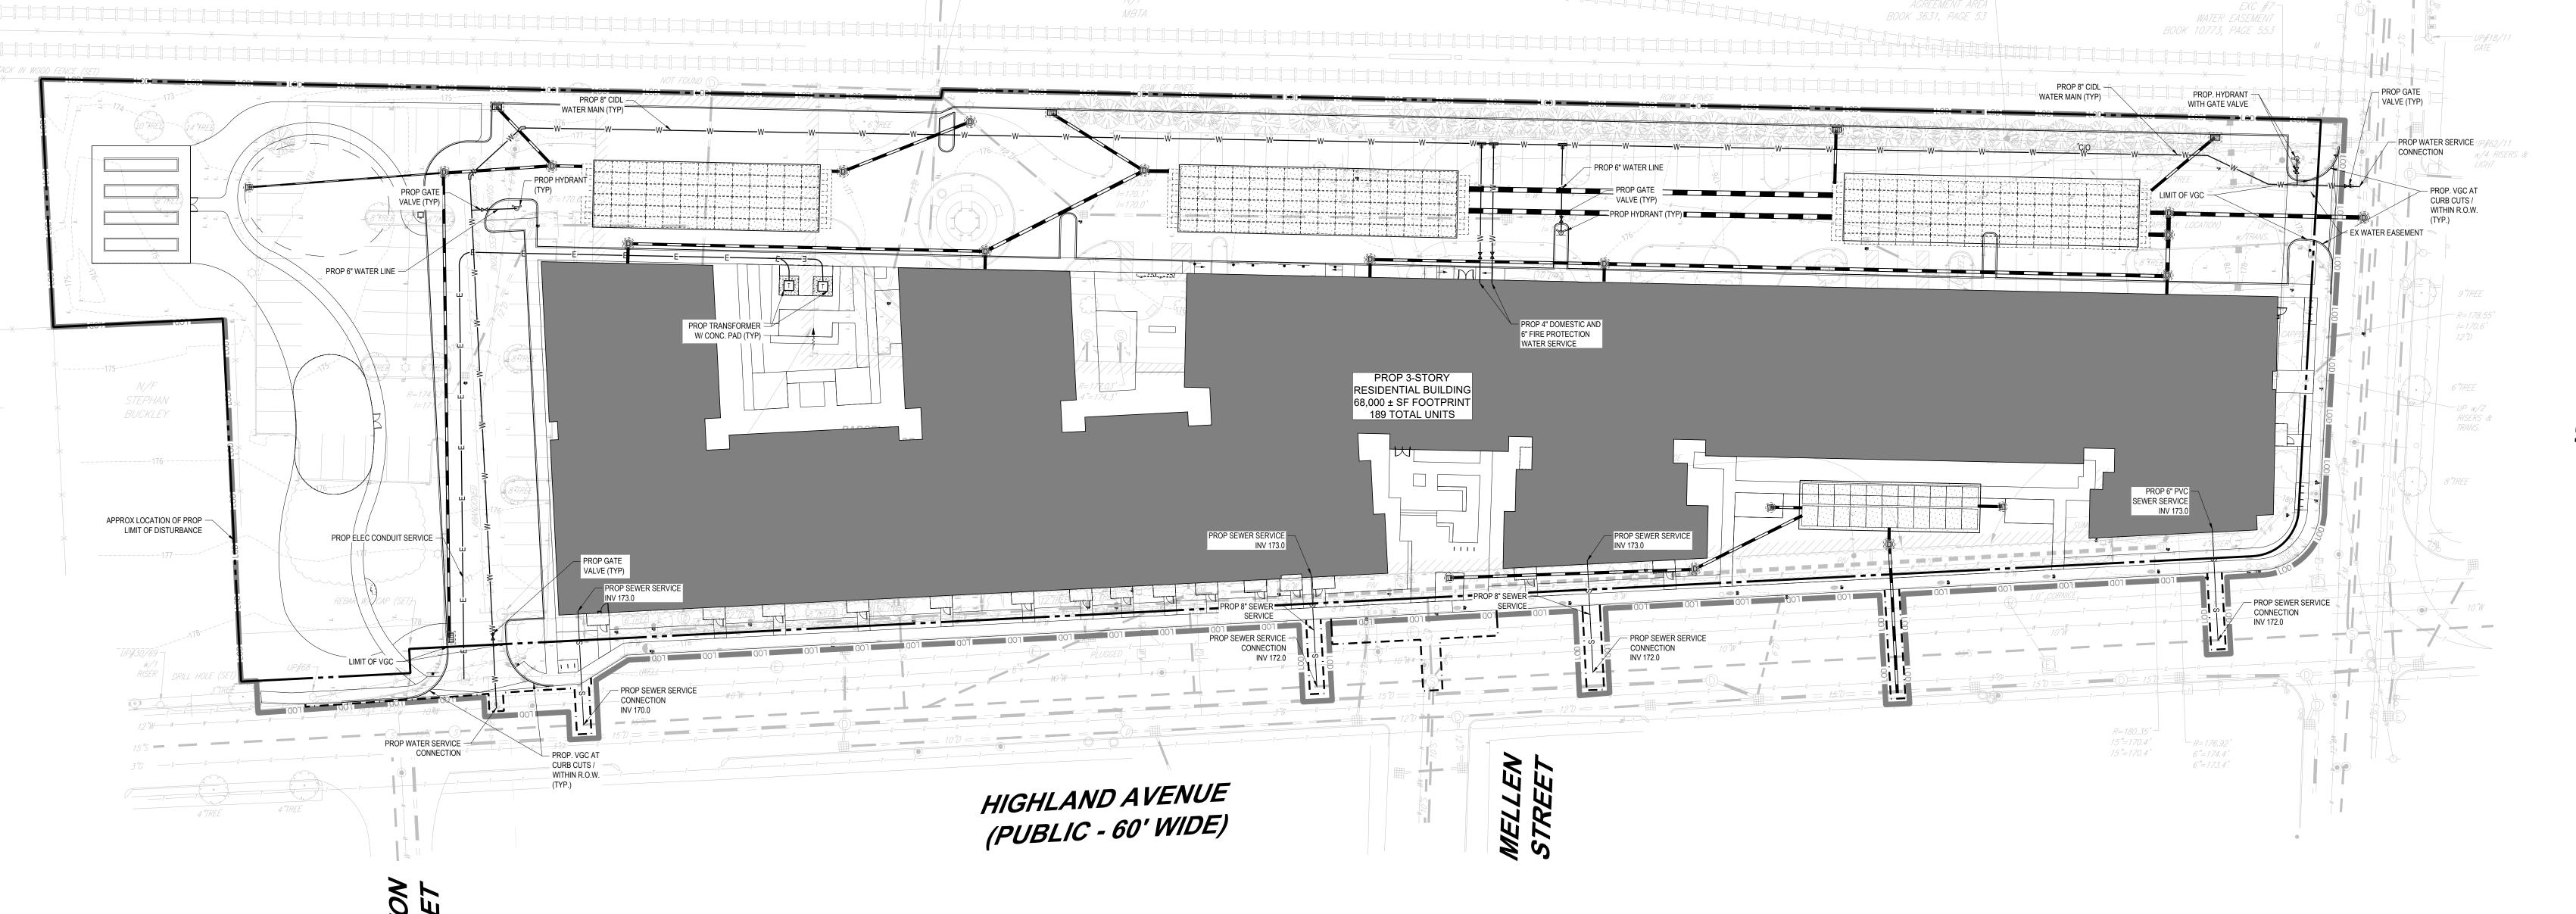

WEST STREET (PUBLIC - 50' WIDE) SITE CIVIL AND CONSULTING ENGINEERING
LAND SURVEYING
PROGRAM MANAGEMENT
LAND SURVEYING
PROGRAM MANAGEMENT
LANDSCAPE ARCHITECTURE
SUSTAINABLE DESIGN
PERMITTING SERVICES
TRANSPORTATION SERVICES
TRANSPORTATION SERVICES

TRANSPORTATION SEALLD PLANS SHALL NOT BE COMPENDED FOR CONSTRUCTION PURPOSES

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REVISIONS

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PROJECT No.:

MAB250036.00
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DEVELOPMENT
PLANS
FOR

GREYSTAR

PROPOSED
RESIDENTIAL DEVELOPMENT

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NORFOLK COUNTY
TOWN OF NEEDHAM
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Z.L. RICHARDS

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PROFESSIONAL ENGINEER

MASSACHUSETTS LICENSE No. 51848

SHEET TITLE:

UTILITY PLAN

C-501

ORG. DATE - 08/12/2025

THIS PLAN TO BE UTILIZED FOR UTILITY PURPOSES ONLY





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ENTITLEMENT SET

THIS DRAWING IS INTENDED FOR MUNICIPAL AND/OR AGENCY EVIEW AND APPROVAL. IT IS NOT INTENDED AS A CONSTRUCTION DOCUMENT UNLESS INDICATED OTHERWISE.

PROJECT No.: MAB250036.00

PROJECT No.: M
DRAWN BY:
CHECKED BY:
DATE:
CAD I.D.:
PROJECT:

GREYSTAR

PROPOSED
RESIDENTIAL DEVELOPMENT
PARCEL ID: 199/063.0-0037-0000.0
100 WEST STREET
NORFOLK COUNTY

BOHLER//

45 FRANKLIN STREET, 5th FLOOR
POSTON, MA 02440

TOWN OF NEEDHAM MASSACHUSETTS

45 FRANKLIN STREET, 5th FLOOR
BOSTON, MA 02110
Phone: (617) 849-8040

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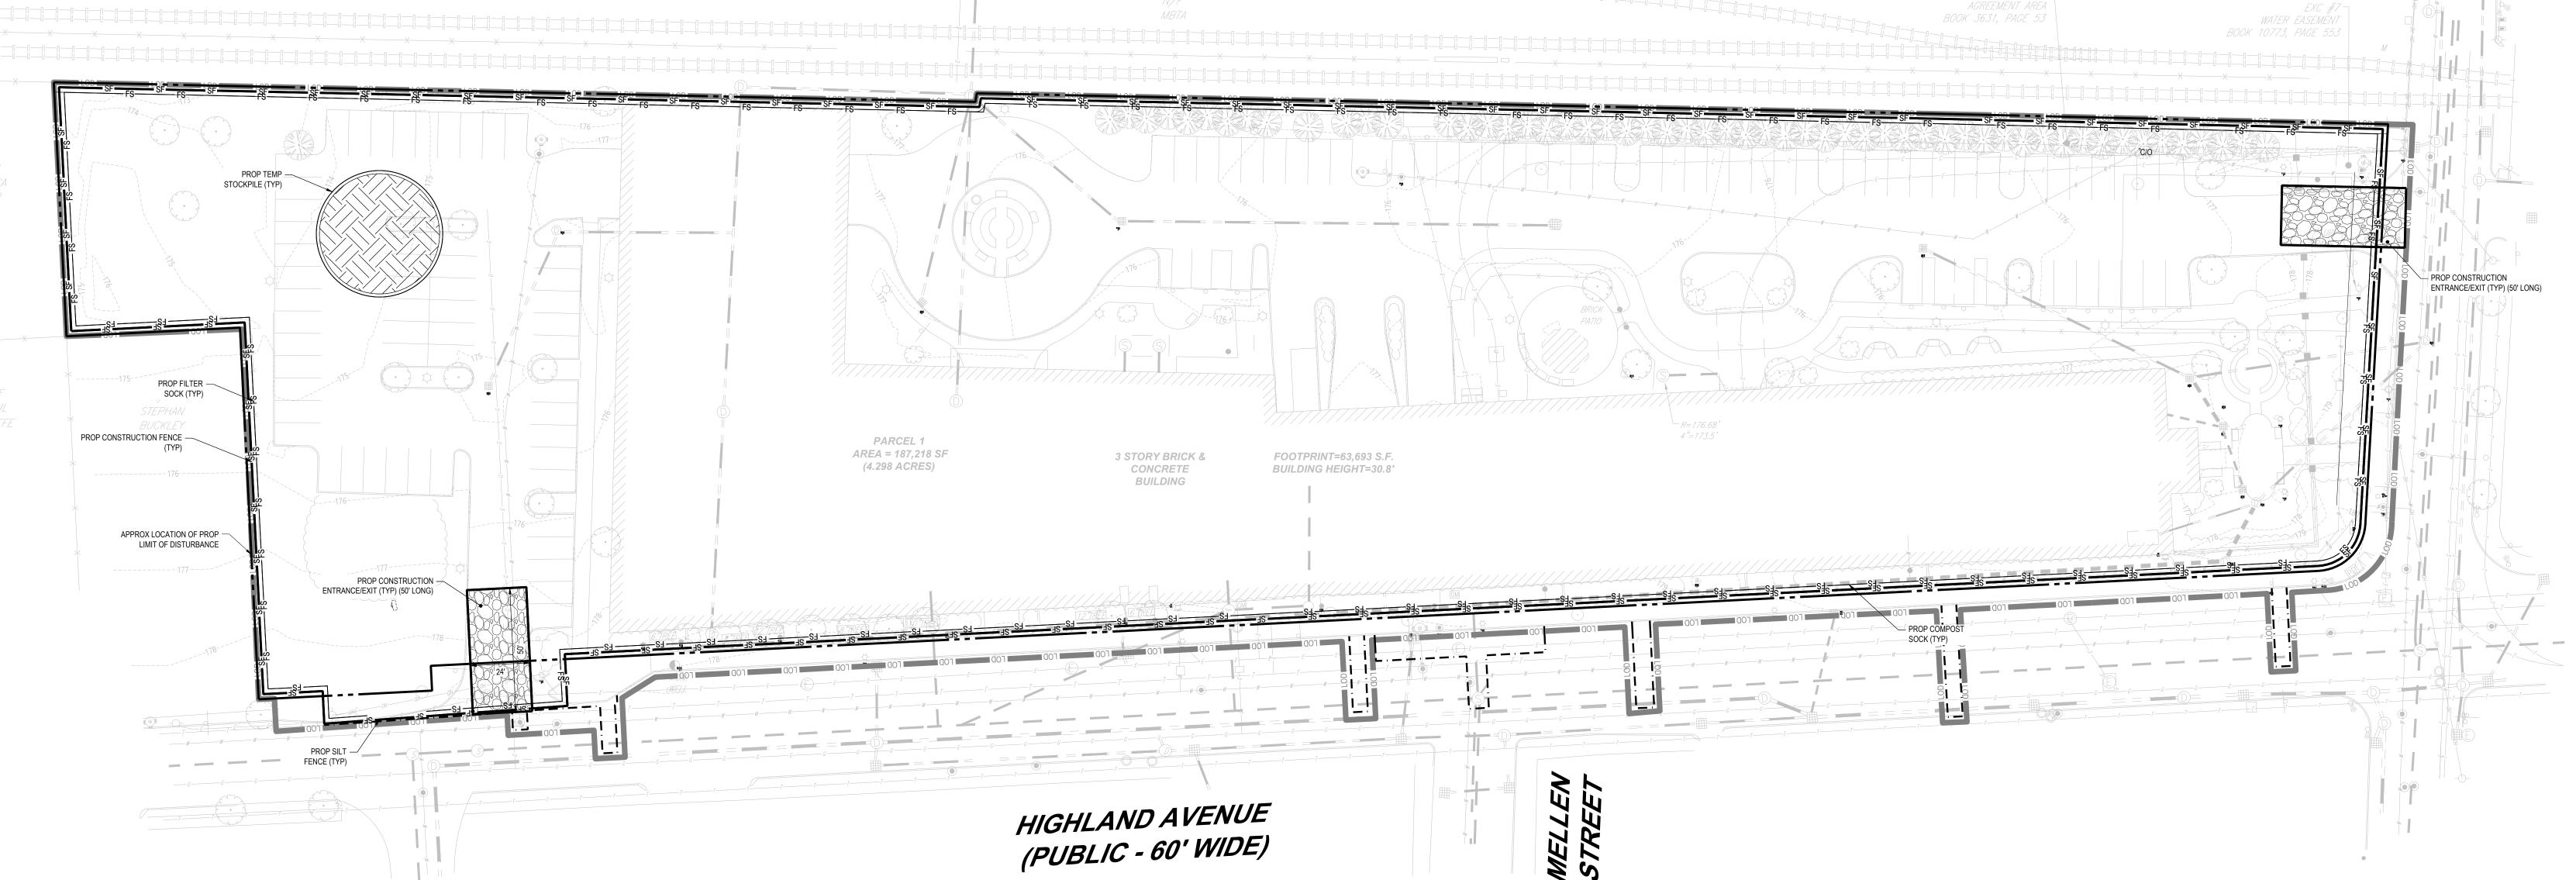


SHEET TITLE:

EROSION &
SEDIMENT
CONTROL
PLAN


C-801

ORG. DATE - 08/12/2025



THIS PLAN TO BE UTILIZED FOR SITE SOIL AND EROSION CONTROL PURPOSES ONLY

REFER TO SOIL EROSION CONTROL
NOTES & DETAIL SHEET FOR EROSION
NOTES AND DETAILS

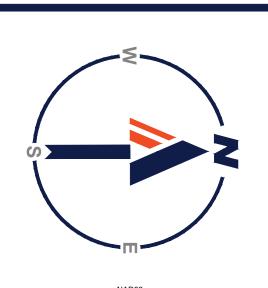

(1) ABC —

(1) QP

COMMUNITY GARDEN

TREES - FOR ALL PARKING AREAS REQUIRING 10 OR MORE SPACES, TREES SHALL BE REQUIRED. ONE TREE SHALL BE PROVIDED FOR EVERY 10 SPACES OR A FRACTION THEREOF. SUCH TREES

DIAMETER, WITH NOT LESS THAN 40 SQUARE FEET OF UNPAVED SOIL OR OTHER PERMEABLE SURFACE AREA PER TREE. PLANTING BEDS SHALL BE AT LEAST 4 FEET WIDE.

BICYCLE RACKS - FOR PARKING AREAS OF FORTY OR MORE SPACES, BICYCLE RACKS FACILITATING LOCKING SHALL BE PROVIDED TO ACCOMMODATE ONE BICYCLE PER TWENTY

PARKING SPACES REQUIRED, OR FRACTION THEREOF.

VISUAL IMPACT OF PARKED VEHICLES AS MUCH AS POSSIBLE. THEY SHALL BE AT LEAST 2" TRUNK

DIAMETER WITH NOT LESS THAN AS COMMENT TO STANK AS COMMENT AS THE PARKING AREA SO AS TO SCREEN AND SOFTEN THE 190 PARKING SPACES / 10 = 20 TREES REQUIRED

190 PARKING SPACES / 20 = 10 BIKE RACKS REQUIRED

CODE	QTY	BOTANICAL NAME	COMMON NAME	SIZE	CONTAINER
CANOF	Y TREE	S			
AR	25	ACER RUBRUM	RED MAPLE	2.5"-3" CAL.	B&B
QP	16	QUERCUS PALUSTRIS	PIN OAK	2.5"-3" CAL.	B&B
TA	14	TILIA AMERICANA	AMERICAN LINDEN	2.5"-3" CAL.	B&B
EVERG ABC	REEN T	REES ABIES CONCOLOR	WHITE FIR	6-8`	B&B
	5			6-8`	B&B
CT	6 39	CHAMAECYPARIS THYOIDES THUJA OCCIDENTALIS `GREEN GIANT`	ATLANTIC WHITE CEDAR GREEN GIANT ARBORVITAE	6-8`	B&B

## **MATERIALS LEGEND**

INER_	SITE PAVING		
	KEY	SYMBOL	DESCRIPTION
	SEE CIVIL DRAWINGS		CONCRETE PAVING
	1 L-302		CONCRETE PAVERS
	6 L-300		PEASTONE GRAVEL
	8		SODDED LAWN

L-300 SITE ELEMENTS

L-302		WITH GATE
<u>2</u> L-302		BLACK ALUM. PICKET FENCE WITH GATE
SITE FURNITU	RE	
<u>2</u> L-301	† † † †	BIKE RACK

<u>2</u> <u>L-301</u>	<b>\$ \$ \$ \$</b>	BIKE RACK
3 L-302	( <del>-</del> 1.co)	GRILL STATION
4 L-302	*	SHADE STRUCTURE
5 L-301	Ģ	DOG BAG DISPENSER
FF&E		SECTIONAL SEATING
FF&E		DINING TABLE

Know what's **below. Call** before you dig.

**REVISIONS** 

REV DATE COMMENT

THIS DRAWING IS INTENDED FOR MUNICIPAL AND/OR AGENCY REVIEW AND APPROVAL. IT IS NOT INTENDED AS A CONSTRUCTION DOCUMENT UNLESS INDICATED OTHERWISE. JGM/DST/CA

PROJECT:


SITE **DEVELOPMENT PLANS** 

**PROPOSED** 

TOWN OF NEEDHAM **MASSACHUSETTS** 

**BOSTON, MA 02110** 

Phone: (617) 849-8040 www.BohlerEngineering.com

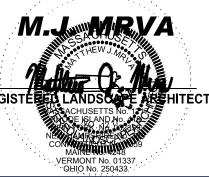

*LANDSCAPE* PLAN

L-100

ORG. DATE - 08/12/2025

AAB250036.00-0C>LAYOUT: L-100 LAND	(1) ABC (56) BIKE RACKS TYP (12 SPACES) (1) TA WILDLIFE CONSERVATION SEEDMIN, TYP. (1) CT (1) AR (1)	ME RACKS, TYP.  MCES  HIGHLAND AVENUE (PUBLIC - 60' WIDE)	(1) CFA  (1) OP  (2) OP  (2) OP  (3) OP  (4) BIKE RACKS, TYP.  (8) SPACES)  (9) OP  (9	(1) AR OUTDOOR SEATING TO BE FRAE, TYP.
MAINTAINED AS LAND OCCUR. LANDSCAPEI BEDS SHALL BE AT LE TEN (10) PERCENT OF PARKING AREAS REQ SHALL BE LOCATED II AREAS SHALL COUNT	NEEDHAM, MA LANDSCAPE REQUIREMENTS  REQUIREMENTS SETBACK AREAS REQUIRED UNDER THE ABOVE PARAGRAPH (J) SHALL BE SCAPED AREAS, EXCEPT WHERE DRIVEWAY OPENINGS OR SIDEWALKS DAREAS SHALL INCLUDE TREES, SHRUBS, FLOWERS AND GRASS. PLANTING AST 4 FEED WIDE. IN ANY PARKING AREA REQUIRING 10 OR MORE SPACES, IMORE OF SUCH AREA SHALL BE MAINTAINED AS LANDSCAPED AREA. IN UIRING 20 OR MORE SPACES, A MINIMUM OF ONE-QUARTER OF THIS AMOUNT IN THE INTERIOR OF THE PARKING AREA. REQUIRED LANDSCAPE SETBACK TOWARDS THE MINIMUM TEN PERCENT REQUIREMENT; PROVIDED, INTERIOR LANDSCAPED AREA REQUIREMENT SHALL BE MET.	A		

CANOPY TREE PLANTING, TYP.

TIMBER SCREEN AT

TRANSFORMERS

SHADE STRUCTURE, TYP.

OUTDOOR SEATING WITH MEDIA WALL

SHADE STRUCTURE WITH OUTDOOR KITCHEN, TYP.

PROP 3-STORY RESIDENTIAL BUILDING

68,000 ± SF FOOTPRINT

189 TOTAL UNITS

STOCKADE FENCE ALONG MBTA TRACKS TO BE REPLACED

NATIVE SHRUB AND —

GROUNDCOVER PLANTING, TYP.

PLANTING, TYP.

DOG RUN

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THIS PLAN TO BE UTILIZED FOR LANDSCAPE PURPOSES ONLY

30' 15' 7.5' 0 30'

(4) BIKE RACKS, TYP. (8 SPACES)

**ENTITLEMENT SET** 


PROJECT No.: DRAWN BY: CHECKED BY: DATE: CAD I.D.: 08/12/2025 P-CIVL-LAND

**G**REYSTAR

RESIDENTIAL DEVELOPMENT PARCEL ID: 199/063.0-0037-0000.0 100 WEST STREET NORFOLK COUNTY





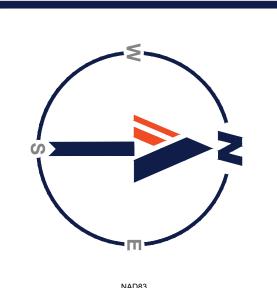

**LIGHTING LEGEND** 

0.900 VP-1-160L-75-3K7-3 0.900 VP-1-160L-75-3K7-4F-HSS-90-B 72 1.000 DW200-12-HO-T3

SYMBOL DESCRIPTION STREETLIGHT PEDESTRIAN LIGHT POLE

REVISIONS					
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PROJECT No.: DRAWN BY: CHECKED BY: DATE: CAD I.D.:

SITE **DEVELOPMENT PLANS** 

**G**REYSTAR


**PROPOSED** PARCEL ID: 199/063.0-0037-0000.0 100 WEST STREET

NORFOLK COUNTY **TOWN OF NEEDHAM MASSACHUSETTS** 

45 FRANKLIN STREET, 5th FLOOR BOSTON, MA 02110

Phone: (617) 849-8040 www.BohlerEngineering.com

M.J.WRVA

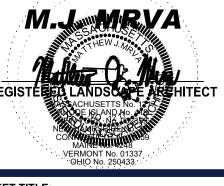


THIS PLAN TO BE UTILIZED FOR LIGHTING PURPOSES ONLY

**LIGHTING** PLAN

L-200

ORG. DATE - 08/12/2025

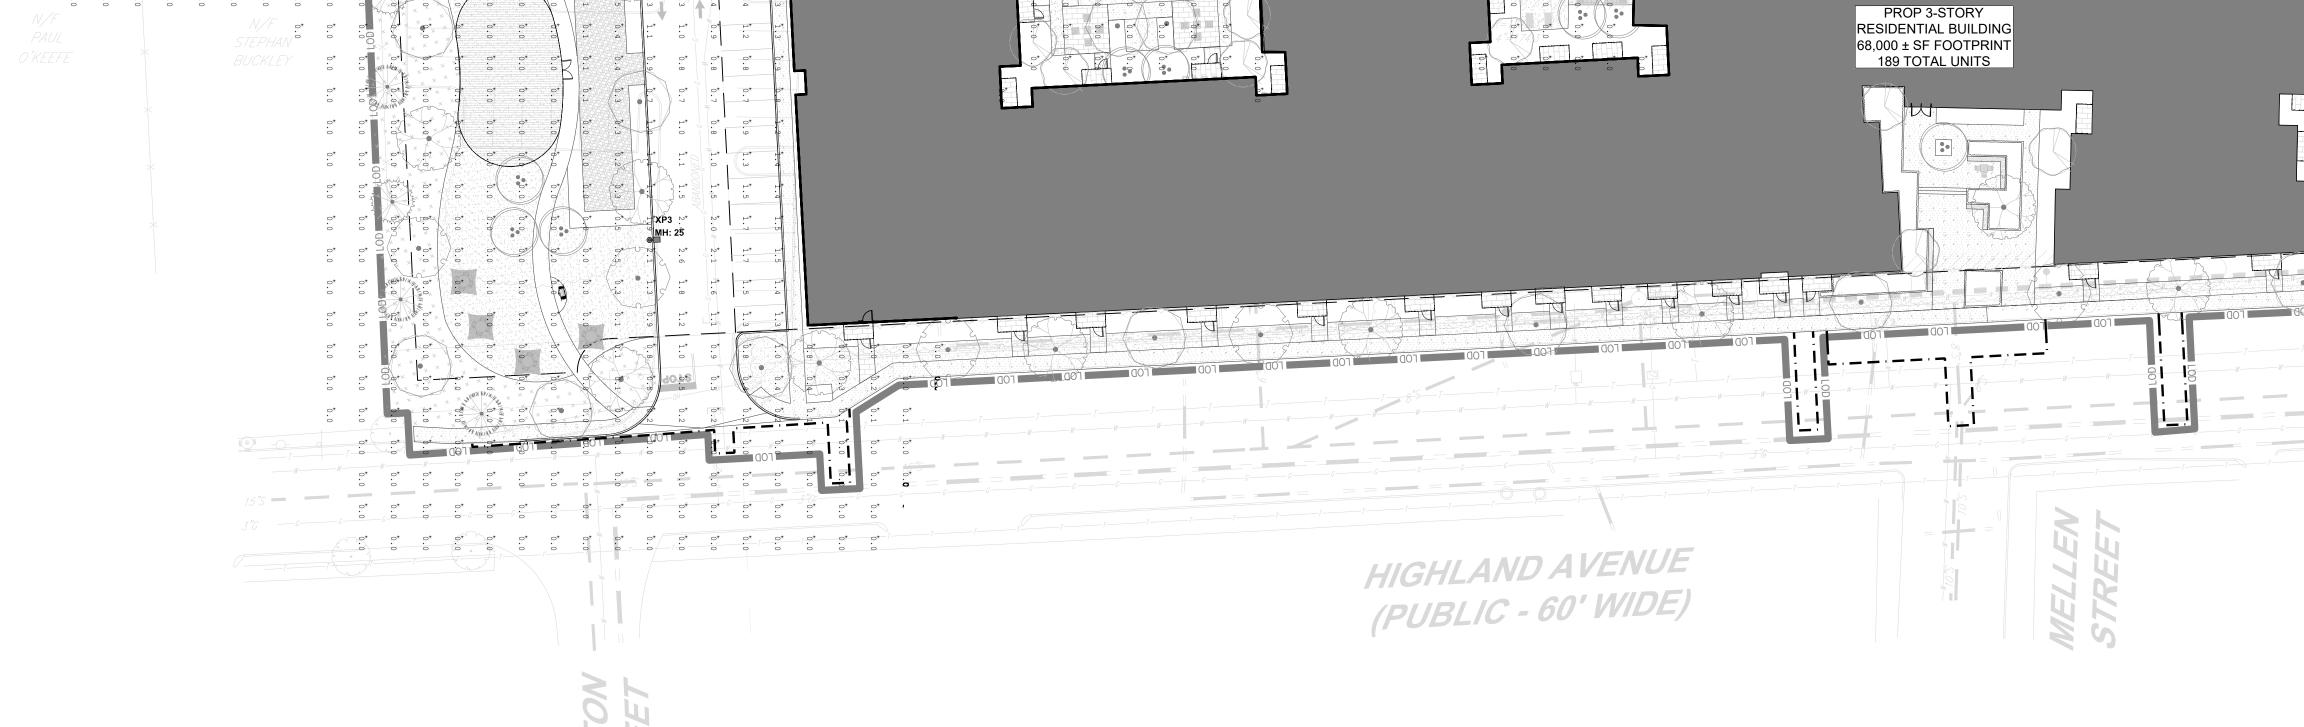

## MASSACHUSETTS LANDSCAPE SPECIFICATION

) FFRTII IZFR·

- i) THE LANDSCAPE CONTRACTOR SHALL BE REQUIRED TO PERFORM ALL CLEARING, FINISHED GRADING, SOIL PREPARATION PERMANENT SEEDING OR SODDING, PLANTING AND MULCHING INCLUDING ALL LABOR, MATERIALS, TOOLS AND EQUIPMENT NECESSARY FOR THE COMPLETION OF THIS PROJECT, UNLESS OTHERWISE CONTRACTED BY THE GENERAL CONTRACTOR.
- **MATERIALS** GENERAL - ALL HARDSCAPE MATERIALS SHALL MEET OR EXCEED SPECIFICATIONS AS OUTLINED IN THE STATE DEPARTMENT OF TRANSPORTATION'S SPECIFICATIONS.
- TOPSOIL NATURAL, FRIABLE, LOAMY SILT SOIL HAVING AN ORGANIC CONTENT NOT LESS THAN 5%, A PH RANGE BETWEEN 4.5-7.0. IT SHALL BE FREE OF DEBRIS, ROCKS LARGER THAN ONE INCH (1"), WOOD, ROOTS, VEGETABLE MATTER AND CLAY
- c)a) ALL DISTURBED AREAS ARE TO BE TREATED WITH A MINIMUM 6" THICK LAYER OF TOPSOIL, OR AS DIRECTED BY THE LOCAL ORDINANCE OR CLIENT, AND SEEDED OR SODDED IN ACCORDANCE WITH THE PERMANENT STABILIZATION METHODS INDICATED ON THE LANDSCAPE PLAN.
- c)b) LAWN SEED MIXTURE SHALL BE FRESH, CLEAN NEW CROP SEED. c)c) SOD SHALL BE STRONGLY ROOTED, WEED AND DISEASE/PEST FREE WITH A UNIFORM THICKNESS. SOD INSTALLED ON SLOPES GREATER THAN 4:1 SHALL BE PEGGED TO HOLD SOD IN PLACE.
- c)d) MULCH ALL PLANTING BEDS SHALL BE MULCHED WITH A 3" THICK LAYER OF DOUBLE SHREDDED HARDWOOD BARK MULCH, UNLESS OTHERWISE STATED ON THE LANDSCAPE PLAN AND/OR LANDSCAPE PLAN NOTES / DETAILS.
- d)a) FERTILIZER SHALL BE DELIVERED TO THE SITE MIXED AS SPECIFIED IN THE ORIGINAL UNOPENED STANDARD BAGS SHOWING WEIGHT, ANALYSIS AND NAME OF MANUFACTURER. FERTILIZER SHALL BE STORED IN A WEATHERPROOF
- PLACE SO THAT IT CAN BE KEPT DRY PRIOR TO USE. d)b) FOR THE PURPOSE OF BIDDING, ASSUME THAT FERTILIZER SHALL BE 10% NITROGEN, 6% PHOSPHORUS AND 4% POTASSIUM BY WEIGHT. A FERTILIZER SHOULD NOT BE SELECTED WITHOUT A SOIL TEST PERFORMED BY A CERTIFIED
- e) PLANT MATERIAL: e)a) ALL PLANTS SHALL IN ALL CASES CONFORM TO THE REQUIREMENTS OF THE "AMERICAN STANDARD FOR NURSERY STOCK" (ANSI Z60.1). LATEST EDITION. AS PUBLISHED BY THE AMERICAN NURSERY & LANDSCAPE ASSOCIATION
- (FORMERLY THE AMERICAN ASSOCIATION OF NURSERYMEN). e)b) IN ALL CASES, BOTANICAL NAMES SHALL TAKE PRECEDENCE OVER COMMON NAMES FOR ANY AND ALL PLANT
- e)c) PLANTS SHALL BE LEGIBLY TAGGED WITH THE PROPER NAME AND SIZE. TAGS ARE TO REMAIN ON AT LEAST ONE PLANT OF EACH SPECIES FOR VERIFICATION PURPOSES DURING THE FINAL INSPECTION.
- e)d) TREES WITH ABRASION OF THE BARK, SUN SCALDS, DISFIGURATION OR FRESH CUTS OF LIMBS OVER 11/4", WHICH HAVE NOT BEEN COMPLETELY CALLUSED, SHALL BE REJECTED. PLANTS SHALL NOT BE BOUND WITH WIRE OR ROPE AT ANY
- TIME SO AS TO DAMAGE THE BARK OR BREAK BRANCHES. e)e) ALL PLANTS SHALL BE TYPICAL OF THEIR SPECIES OR VARIETY AND SHALL HAVE A NORMAL HABIT OF GROWTH: WELL DEVELOPED BRANCHES, DENSELY FOLIATED, VIGOROUS ROOT SYSTEMS AND BE FREE OF DISEASE, INSECTS, PESTS,
- CALIPER MEASUREMENTS OF NURSERY GROWN TREES SHALL BE TAKEN AT A POINT ON THE TRUNK SIX INCHES (6") ABOVE THE NATURAL GRADE FOR TREES UP TO AND INCLUDING A FOUR INCH (4") CALIPER SIZE. IF THE CALIPER AT SIX INCHES (6") ABOVE THE GROUND EXCEEDS FOUR INCHES (4") IN CALIPER, THE CALIPER SHOULD BE MEASURED AT A
- POINT 12" ABOVE THE NATURAL GRADE. e)g) SHRUBS SHALL BE MEASURED TO THE AVERAGE HEIGHT OR SPREAD OF THE SHRUB, AND NOT TO THE LONGEST
- e)h) TREES AND SHRUBS SHALL BE HANDLED WITH CARE BY THE ROOT BALL. GENERAL WORK PROCEDURES
- CONTRACTOR TO UTILIZE WORKMANLIKE INDUSTRY STANDARDS IN PERFORMING ALL LANDSCAPE CONSTRUCTION. THE SITE IS TO BE LEFT IN A CLEAN STATE AT THE END OF EACH WORKDAY. ALL DEBRIS, MATERIALS AND TOOLS SHALL BE PROPERLY STORED. STOCKPILED OR DISPOSED OF
- WASTE MATERIALS AND DEBRIS SHALL BE COMPLETELY DISPOSED OF AT THE CONTRACTOR'S EXPENSE. DEBRIS SHALL NOT BE BURIED, INCLUDING ORGANIC MATERIALS, BUT SHALL BE REMOVED COMPLETELY FROM THE SITE SITE PREPARATIONS
- BEFORE AND DURING PRELIMINARY GRADING AND FINISHED GRADING, ALL WEEDS AND GRASSES SHALL BE DUG OUT BY THE ROOTS AND DISPOSED OF IN ACCORDANCE WITH GENERAL WORK PROCEDURES OUTLINED HEREIN. ALL EXISTING TREES TO REMAIN SHALL BE PRUNED TO REMOVE ANY DAMAGED BRANCHES. THE ENTIRE LIMB OF ANY DAMAGED BRANCH SHALL BE CUT OFF AT THE BRANCH COLLAR. CONTRACTOR SHALL ENSURE THAT CUTS ARE SMOOTH
- AROUND THE REMAINDER OF THE ROOTS. EXISTING TREES SHALL BE MONITORED ON A REGULAR BASIS FOR ADDITIONAL ROOT OR BRANCH DAMAGE AS A RESULT OF CONSTRUCTION. ROOTS SHALL NOT BE LEFT EXPOSED FOR MORE THAN ONE (1) DAY. CONTRACTOR SHALL WATER EXISTING TREES AS NEEDED TO PREVENT SHOCK OR DECLINE. CONTRACTOR SHALL ARRANGE TO HAVE A UTILITY STAKE-OUT TO LOCATE ALL UNDERGROUND UTILITIES PRIOR TO INSTALLATION OF ANY LANDSCAPE MATERIAL. UTILITY COMPANIES SHALL BE CONTACTED THREE (3) DAYS PRIOR TO THE

AND STRAIGHT. ANY EXPOSED ROOTS SHALL BE CUT BACK WITH CLEAN. SHARP TOOLS AND TOPSOIL SHALL BE PLACED

- BEGINNING OF WORK. TREE PROTECTION CONTRACTOR SHALL BE RESPONSIBLE FOR THE PROTECTION OF ALL EXISTING TREES TO REMAIN. A TREE PROTECTION ZONE SHALL BE ESTABLISHED AT THE DRIPLINE OR AT THE LIMIT OF CONSTRUCTION DISTURBANCE. WHICHEVER IS
- GREATER. LOCAL STANDARDS THAT MAY REQUIRE A MORE STRICT TREE PROTECTION ZONE SHALL BE HONORED. A FORTY-EIGHT INCH (48") HIGH WOODEN SNOW FENCE OR ORANGE COLORED HIGH-DENSITY 'VISI-FENCE'. OR APPROVED EQUAL, MOUNTED ON STEEL POSTS SHALL BE PLACED ALONG THE BOUNDARY OF THE TREE PROTECTION ZONE. POSTS SHALL BE LOCATED AT A MAXIMUM OF EIGHT FEET (8') ON CENTER OR AS INDICATED WITHIN THE TREE PROTECTION DETAIL. WHEN THE TREE PROTECTION FENCING HAS BEEN INSTALLED. IT SHALL BE INSPECTED BY THE APPROVING AGENCY PRIOR TO DEMOLITION, GRADING, TREE CLEARING OR ANY OTHER CONSTRUCTION. THE FENCING ALONG THE TREE PROTECTION
- ACTIVITY HAS BEEN COMPLETED AT NO TIME SHALL MACHINERY, DEBRIS, FALLEN TREES OR OTHER MATERIALS BE PLACED, STOCKPILED OR LEFT STANDING IN THE TREE PROTECTION ZONE.

ZONE SHALL BE REGULARLY INSPECTED BY THE LANDSCAPE CONTRACTOR AND MAINTAINED UNTIL ALL CONSTRUCTION

- SOIL MODIFICATIONS ) CONTRACTOR SHALL ATTAIN A SOIL TEST FOR ALL AREAS OF THE SITE PRIOR TO CONDUCTING ANY PLANTING. SOIL TESTS SHALL BE PERFORMED BY A CERTIFIED SOIL LABORATORY. LANDSCAPE CONTRACTOR SHALL REPORT ANY SOIL OR DRAINAGE CONDITIONS CONSIDERED DETRIMENTAL TO THE
- GROWTH OF PLANT MATERIAL. SOIL MODIFICATIONS, AS SPECIFIED HEREIN, MAY NEED TO BE CONDUCTED BY THE LANDSCAPE CONTRACTOR DEPENDING ON SITE CONDITIONS THE FOLLOWING AMENDMENTS AND QUANTITIES ARE APPROXIMATE AND ARE FOR BIDDING PURPOSES ONLY. COMPOSITION OF AMENDMENTS SHOULD BE REVISED DEPENDING ON THE OUTCOME OF A TOPSOIL ANALYSIS PERFORMED
- BY A CERTIFIED SOIL LABORATORY TO INCREASE A SANDY SOIL'S ABILITY TO RETAIN WATER AND NUTRIENTS. THOROUGHLY TILL ORGANIC MATTER INTO THE TOP 6-12". USE COMPOSTED BARK, COMPOSTED LEAF MULCH OR PEAT MOSS. ALL PRODUCTS SHOULD BE COMPOSTED TO A DARK COLOR AND BE FREE OF PIECES WITH IDENTIFIABLE LEAF OR WOOD STRUCTURE. AVOID MATERIAL WITH A PH
- d)a) TO INCREASE DRAINAGE, MODIFY HEAVY CLAY OR SILT (MORE THAN 40% CLAY OR SILT) BY ADDING COMPOSTED PINE BARK (UP TO 30% BY VOLUME) AND/OR AGRICULTURAL GYPSUM. COARSE SAND MAY BE USED IF ENOUGH IS ADDED TO BRING THE SAND CONTENT TO MORE THAN 60% OF THE TOTAL MIX. SUBSURFACE DRAINAGE LINES MAY NEED TO BE ADDED TO INCREASE DRAINAGE
- d)b) MODIFY EXTREMELY SANDY SOILS (MORE THAN 85%) BY ADDING ORGANIC MATTER AND/OR DRY, SHREDDED CLAY LOAM UP TO 30% OF THE TOTAL MIX. FINISHED GRADING
- UNLESS OTHERWISE CONTRACTED, THE LANDSCAPE CONTRACTOR SHALL BE RESPONSIBLE FOR THE INSTALLATION OF TOPSOIL AND THE ESTABLISHMENT OF FINE-GRADING WITHIN THE DISTURBANCE AREA OF THE SITE. LANDSCAPE CONTRACTOR SHALL VERIFY THAT SUBGRADE FOR INSTALLATION OF TOPSOIL HAS BEEN ESTABLISHED. THE
- SUBGRADE OF THE SITE MUST MEET THE FINISHED GRADE LESS THE REQUIRED TOPSOIL THICKNESS (1"±). ALL LAWN AND PLANTING AREAS SHALL BE GRADED TO A SMOOTH, EVEN AND UNIFORM PLANE WITH NO ABRUPT CHANGE OF SURFACE AS DEPICTED WITHIN THIS SET OF CONSTRUCTION PLANS, UNLESS OTHERWISE DIRECTED BY THE PROJECT ENGINEER OR LANDSCAPE ARCHITECT. ALL PLANTING AREAS SHALL BE GRADED AND MAINTAINED TO ALLOW FREE FLOW OF SURFACE WATER IN AND AROUND THE
- PLANTING BEDS. STANDING WATER SHALL NOT BE PERMITTED IN PLANTING BEDS.
- CONTRACTOR SHALL PROVIDE A 6" THICK MINIMUM LAYER OF TOPSOIL FOR THE NEW ENGLAND SHOWY WILDFLOWER MIX AREA. OR AS DIRECTED BY THE LOCAL ORDINANCE OR CLIENT, IN ALL PLANTING AREAS. TOPSOIL SHOULD BE SPREAD

OVER A PREPARED SURFACE IN A UNIFORM LAYER TO ACHIEVE THE DESIRED COMPACTED THICKNESS.

- ON-SITE TOPSOIL MAY BE USED TO SUPPLEMENT THE TOTAL AMOUNT REQUIRED. TOPSOIL FROM THE SITE MAY BE REJECTED IF IT HAS NOT BEEN PROPERLY REMOVED, STORED AND PROTECTED PRIOR TO CONSTRUCTION. CONTRACTOR SHALL FURNISH TO THE APPROVING AGENCY AN ANALYSIS OF BOTH IMPORTED AND ON-SITE TOPSOIL TO BE
- UTILIZED IN ALL PLANTING AREAS. THE PH AND NUTRIENT LEVELS MAY NEED TO BE ADJUSTED THROUGH SOIL MODIFICATIONS AS NEEDED TO ACHIEVE THE REQUIRED LEVELS AS SPECIFIED IN THE MATERIALS SECTION ABOVE. THE SPREADING OF TOPSOIL SHALL NOT BE CONDUCTED UNDER MUDDY OR FROZEN CONDITIONS.
- e) CONTRACTOR SHALL TEST AND AMEND EXISTING TOPSOIL AS ADVISED BY A SOIL SCIENTIST FOR THE NEW ENGLAND CONSERVATION MIX AREA AND HYDROSEEDED LAWN AREAS. PLANTING

- a) INSOFAR THAT IT IS FEASIBLE. PLANT MATERIAL SHALL BE PLANTED ON THE DAY OF DELIVERY. IN THE EVENT THAT THIS IS NOT POSSIBLE LANDSCAPE CONTRACTOR SHALL PROTECT UNINSTALLED PLANT MATERIAL. PLANTS SHALL NOT REMAIN. UNPLANTED FOR LONGER THAN A THREE DAY PERIOD AFTER DELIVERY. PLANTS THAT WILL NOT BE PLANTED FOR A PERIOD OF TIME GREATER THAN THREE DAYS SHALL BE HEALED IN WITH TOPSOIL OR MULCH TO HELP PRESERVE ROOT MOISTURE. b) PLANTING OPERATIONS SHALL BE PERFORMED DURING PERIODS WITHIN THE PLANTING SEASON WHEN WEATHER AND SOIL CONDITIONS ARE SUITABLE AND IN ACCORDANCE WITH ACCEPTED LOCAL PRACTICE. PLANTS SHALL NOT BE INSTALLED IN
- TOPSOIL THAT IS IN A MUDDY OR FROZEN CONDITION. ) ANY INJURED ROOTS OR BRANCHES SHALL BE PRUNED TO MAKE CLEAN-CUT ENDS PRIOR TO PLANTING UTILIZING CLEAN.
- SHARP TOOLS. ONLY INJURED OR DISEASED BRANCHING SHALL BE REMOVED.
- d) ALL PLANTING CONTAINERS. BASKETS AND NON-BIODEGRADABLE MATERIALS SHALL BE REMOVED FROM ROOT BALLS DURING PLANTING. NATURAL FIBER BURLAP MUST BE CUT FROM AROUND THE TRUNK OF THE TREE AND FOLDED DOWN AGAINST THE ROOT BALL PRIOR TO BACKFILLING.
- e) POSITION TREES AND SHRUBS AT THEIR INTENDED LOCATIONS AS PER THE PLANS AND SECURE THE APPROVAL OF THE LANDSCAPE ARCHITECT PRIOR TO EXCAVATING PITS, MAKING NECESSARY ADJUSTMENTS AS DIRECTED. PRIOR TO THE ISSUANCE OF ANY CERTIFICATE OF OCCUPANCY, THE PROPOSED LANDSCAPE, AS SHOWN ON THE APPROVED LANDSCAPE PLAN, MUST BE INSTALLED, INSPECTED AND APPROVED BY THE APPROVING AGENCY. THE APPROVING AGENCY SHALL TAKE INTO ACCOUNT SEASONAL CONSIDERATIONS IN THIS REGARD AS FOLLOWS. THE

PLANTING OF TREES, SHRUBS, VINES OR GROUND COVER SHALL OCCUR ONLY DURING THE FOLLOWING PLANTING


- f)a) PLANTS: MARCH 15 TO DECEMBER 15
- f)b) LAWN: MARCH 15 TO JUNE 15 OR SEPT. 1 TO DECEMBER 1 f)c) PLANTINGS REQUIRED FOR A CERTIFICATE OF OCCUPANCY SHALL BE PROVIDED DURING THE NEXT APPROPRIATE SEASON AT THE MUNICIPALITY'S DISCRETION. CONTRACTOR SHOULD CONTACT APPROVING AGENCY FOR POTENTIAL
- g) FURTHERMORE, THE FOLLOWING TREE VARIETIES ARE UNUSUALLY SUSCEPTIBLE TO WINTER DAMAGE. WITH TRANSPLANT SHOCK AND THE SEASONAL LACK OF NITROGEN AVAILABILITY. THE RISK OF PLANT DEATH IS GREATLY INCREASED. IT IS NOT RECOMMENDED THAT THESE SPECIES BE PLANTED DURING THE FALL PLANTING SEASON:
  - ACER RUBRUM PLATANUS X ACERIFOLIA BETULA VARIETIES POPULUS VARIETIES CARPINUS VARIETIES PRUNUS VARIETIES **CRATAEGUS VARIETIES** PYRUS VARIETIES
- KOELREUTERIA QUERCUS VARIETIES LIQUIDAMBAR STYRACIFLUA TILIA TOMENTOSA LIRIODENDRON TULIPIFERA ZELKOVA VARIETIES
- h) PLANTING PITS SHALL BE DUG WITH LEVEL BOTTOMS, WITH THE WIDTH TWICE THE DIAMETER OF ROOT BALL. THE ROOT BALL SHALL REST ON UNDISTURBED GRADE. EACH PLANT PIT SHALL BE BACKFILLED IN LAYERS WITH THE FOLLOWING PREPARED SOIL MIXED THOROUGHLY:
- h)a) 1 PART PEAT MOSS h)b) 1 PART COMPOSTED COW MANURE BY VOLUME
- h)c) 3 PARTS TOPSOIL BY VOLUME
- h)d) 21 GRAMS 'AGRIFORM' PLANTING TABLETS (OR APPROVED EQUAL) AS FOLLOWS:


h)d)c) 4 TABLETS PER 15 GALLON PLANT


- h)d)a) 2 TABLETS PER 1 GALLON PLANT h)d)b) 3 TABLETS PER 5 GALLON PLANT
- h)d)d) LARGER PLANTS: 2 TABLETS PER ½" CALIPER OF TRUNK i) FILL PREPARED SOIL AROUND BALL OF PLANT HALF-WAY AND INSERT PLANT TABLETS. COMPLETE BACKFILL AND WATER
- ALL PLANTS SHALL BE PLANTED SO THAT THE TOP OF THE ROOT BALL. THE POINT AT WHICH THE ROOT FLARE BEGINS. IS SET AT GROUND LEVEL AND IN THE CENTER OF THE PIT. NO SOIL IS TO BE PLACED DIRECTLY ON TOP OF THE ROOT BALL. k) ALL PROPOSED TREES DIRECTLY ADJACENT TO WALKWAYS OR DRIVEWAYS SHALL BE PRUNED AND MAINTAINED TO A
- MINIMUM BRANCHING HEIGHT OF 7' FROM GRADE. GROUND COVER AREAS SHALL RECEIVE A 1/4" LAYER OF HUMUS RAKED INTO THE TOP 1" OF PREPARED SOIL PRIOR TO PLANTING. ALL GROUND COVER AREAS SHALL BE WEEDED AND TREATED WITH A PRE-EMERGENT CHEMICAL AS PER
- MANUFACTURER'S RECOMMENDATION. m) NO PLANT, EXCEPT GROUND COVERS, GRASSES OR VINES, SHALL BE PLANTED LESS THAN TWO FEET (2') FROM EXISTING STRUCTURES AND SIDEWALKS.
- n) ALL PLANTING AREAS AND PLANTING PITS SHALL BE MULCHED AS SPECIFIED HEREIN TO FILL THE ENTIRE BED AREA OR SAUCER. NO MULCH IS TO TOUCH THE TRUNK OF THE TREE OR SHRUB. o) ALL PLANTING AREAS SHALL BE WATERED IMMEDIATELY UPON INSTALLATION IN ACCORDANCE WITH THE WATERING
- SPECIFICATIONS AS LISTED HEREIN. 10. TRANSPLANTING (WHEN REQUIRED)
- a) ALL TRANSPLANTS SHALL BE DUG WITH INTACT ROOT BALLS CAPABLE OF SUSTAINING THE PLANT. b) IF PLANTS ARE TO BE STOCKPILED BEFORE REPLANTING, THEY SHALL BE HEALED IN WITH MULCH OR SOIL, ADEQUATELY
- WATERED AND PROTECTED FROM EXTREME HEAT, SUN AND WIND. c) PLANTS SHALL NOT BE DUG FOR TRANSPLANTING BETWEEN APRIL 10 AND JUNE 30.
- d) UPON REPLANTING, BACKFILL SOIL SHALL BE AMENDED WITH FERTILIZER AND ROOT GROWTH HORMONE. e) TRANSPLANTS SHALL BE GUARANTEED FOR THE LENGTH OF THE GUARANTEE PERIOD SPECIFIED HEREIN.
- f) F TRANSPLANTS DIE, SHRUBS AND TREES LESS THAN SIX INCHES (6") DBH SHALL BE REPLACED IN KIND. TREES GREATER THAN SIX INCHES (6") DBH MAY BE REQUIRED TO BE REPLACED IN ACCORDANCE WITH THE MUNICIPALITY'S TREE REPLACEMENT GUIDELINES.
- 11. WATERING a) NEW PLANTINGS OR LAWN AREAS SHALL BE ADEQUATELY IRRIGATED BEGINNING IMMEDIATELY AFTER PLANTING. WATER SHALL BE APPLIED TO EACH TREE AND SHRUB IN SUCH MANNER AS NOT TO DISTURB BACKFILL AND TO THE EXTENT THAT ALL MATERIALS IN THE PLANTING HOLE ARE THOROUGHLY SATURATED. WATERING SHALL CONTINUE AT LEAST UNTIL
- PLANTS ARE ESTABLISHED. b) SITE OWNER SHALL PROVIDE WATER IF AVAILABLE ON SITE AT TIME OF PLANTING. IF WATER IS NOT AVAILABLE ON SITE, CONTRACTOR SHALL SUPPLY ALL NECESSARY WATER. THE USE OF WATERING BAGS IS RECOMMENDED FOR ALL NEWLY
- c) IF AN IRRIGATION SYSTEM HAS BEEN INSTALLED ON THE SITE, IT SHALL BE USED TO WATER PROPOSED PLANT MATERIAL, BUT ANY FAILURE OF THE SYSTEM DOES NOT ELIMINATE THE CONTRACTOR'S RESPONSIBILITY OF MAINTAINING THE
- DESIRED MOISTURE LEVEL FOR VIGOROUS. HEALTHY GROWTH 12. GUARANTEE a) THE LANDSCAPE CONTRACTOR SHALL GUARANTEE ALL PLANTS FOR A PERIOD OF 1 YEAR FROM APPROVAL OF LANDSCAPE
- INSTALLATION BY THE APPROVING AGENCY. CONTRACTOR SHALL SUPPLY THE OWNER WITH A MAINTENANCE BOND FOR TEN PERCENT (10%) OF THE VALUE OF THE LANDSCAPE INSTALLATION WHICH WILL BE RELEASED AT THE CONCLUSION OF THE GUARANTEE PERIOD AND WHEN A FINAL INSPECTION HAS BEEN COMPLETED AND APPROVED BY THE OWNER OR AUTHORIZED REPRESENTATIVE.
- b) ANY DEAD OR DYING PLANT MATERIAL SHALL BE REPLACED FOR THE LENGTH OF THE GUARANTEE PERIOD. REPLACEMENT OF PLANT MATERIAL SHALL BE CONDUCTED AT THE FIRST SUCCEEDING PLANTING SEASON. ANY DEBRIS SHALL BE DISPOSED OF OFF-SITE. WITHOUT EXCEPTION.
- TREES AND SHRUBS SHALL BE MAINTAINED BY THE CONTRACTOR DURING CONSTRUCTION AND THROUGHOUT THE 90 DAY MAINTENANCE PERIOD AS SPECIFIED HEREIN. CULTIVATION, WEEDING, WATERING AND THE PREVENTATIVE TREATMENTS SHALL BE PERFORMED AS NECESSARY TO KEEP PLANT MATERIAL IN GOOD CONDITION AND FREE OF INSECTS AND DISEASE. d) LAWNS SHALL BE MAINTAINED THROUGH WATERING, FERTILIZING, WEEDING, MOWING, TRIMMING AND OTHER OPERATIONS SUCH AS ROLLING. REGARDING AND REPLANTING AS REQUIRED TO ESTABLISH A SMOOTH, ACCEPTABLE LAWN, FREE OF
- 13. CLEANUP a) UPON THE COMPLETION OF ALL LANDSCAPE INSTALLATION AND BEFORE THE FINAL ACCEPTANCE, THE CONTRACTOR SHALL REMOVE ALL UNUSED MATERIALS, EQUIPMENT AND DEBRIS FROM THE SITE. ALL PAVED AREAS ARE TO BE CLEANED. b) THE SITE SHALL BE CLEANED AND LEFT IN A NEAT AND ACCEPTABLE CONDITION AS APPROVED BY THE OWNER OR
- AUTHORIZED REPRESENTATIVE 14. MAINTENANCE (ALTERNATIVE BID):


ERODED OR BARE AREAS.

a) A 90 DAY MAINTENANCE PERIOD SHALL COMMENCE AT THE END OF ALL LANDSCAPE INSTALLATION OPERATIONS. THE 90 DAY MAINTENANCE PERIOD ENSURES TO THE OWNER/OPERATOR THAT THE NEWLY INSTALLED LANDSCAPING HAS BEEN MAINTAINED AS SPECIFIED ON THE APPROVED LANDSCAPE PLAN. ONCE THE INITIAL 90 DAY MAINTENANCE PERIOD HAS EXPIRED, THE OWNER/OPERATOR MAY REQUEST THAT BIDDERS SUBMIT AN ALTERNATE MAINTENANCE BID FOR A MONTHLY MAINTENANCE CONTRACT. THE ALTERNATE MAINTENANCE CONTRACT WILL ENCOMPASS ANY WORK THAT IS CONSIDERED APPROPRIATE TO ENSURE THAT PLANT AND LAWN AREAS ARE HEALTHY AND MANICURED TO THE APPROVAL OF THE

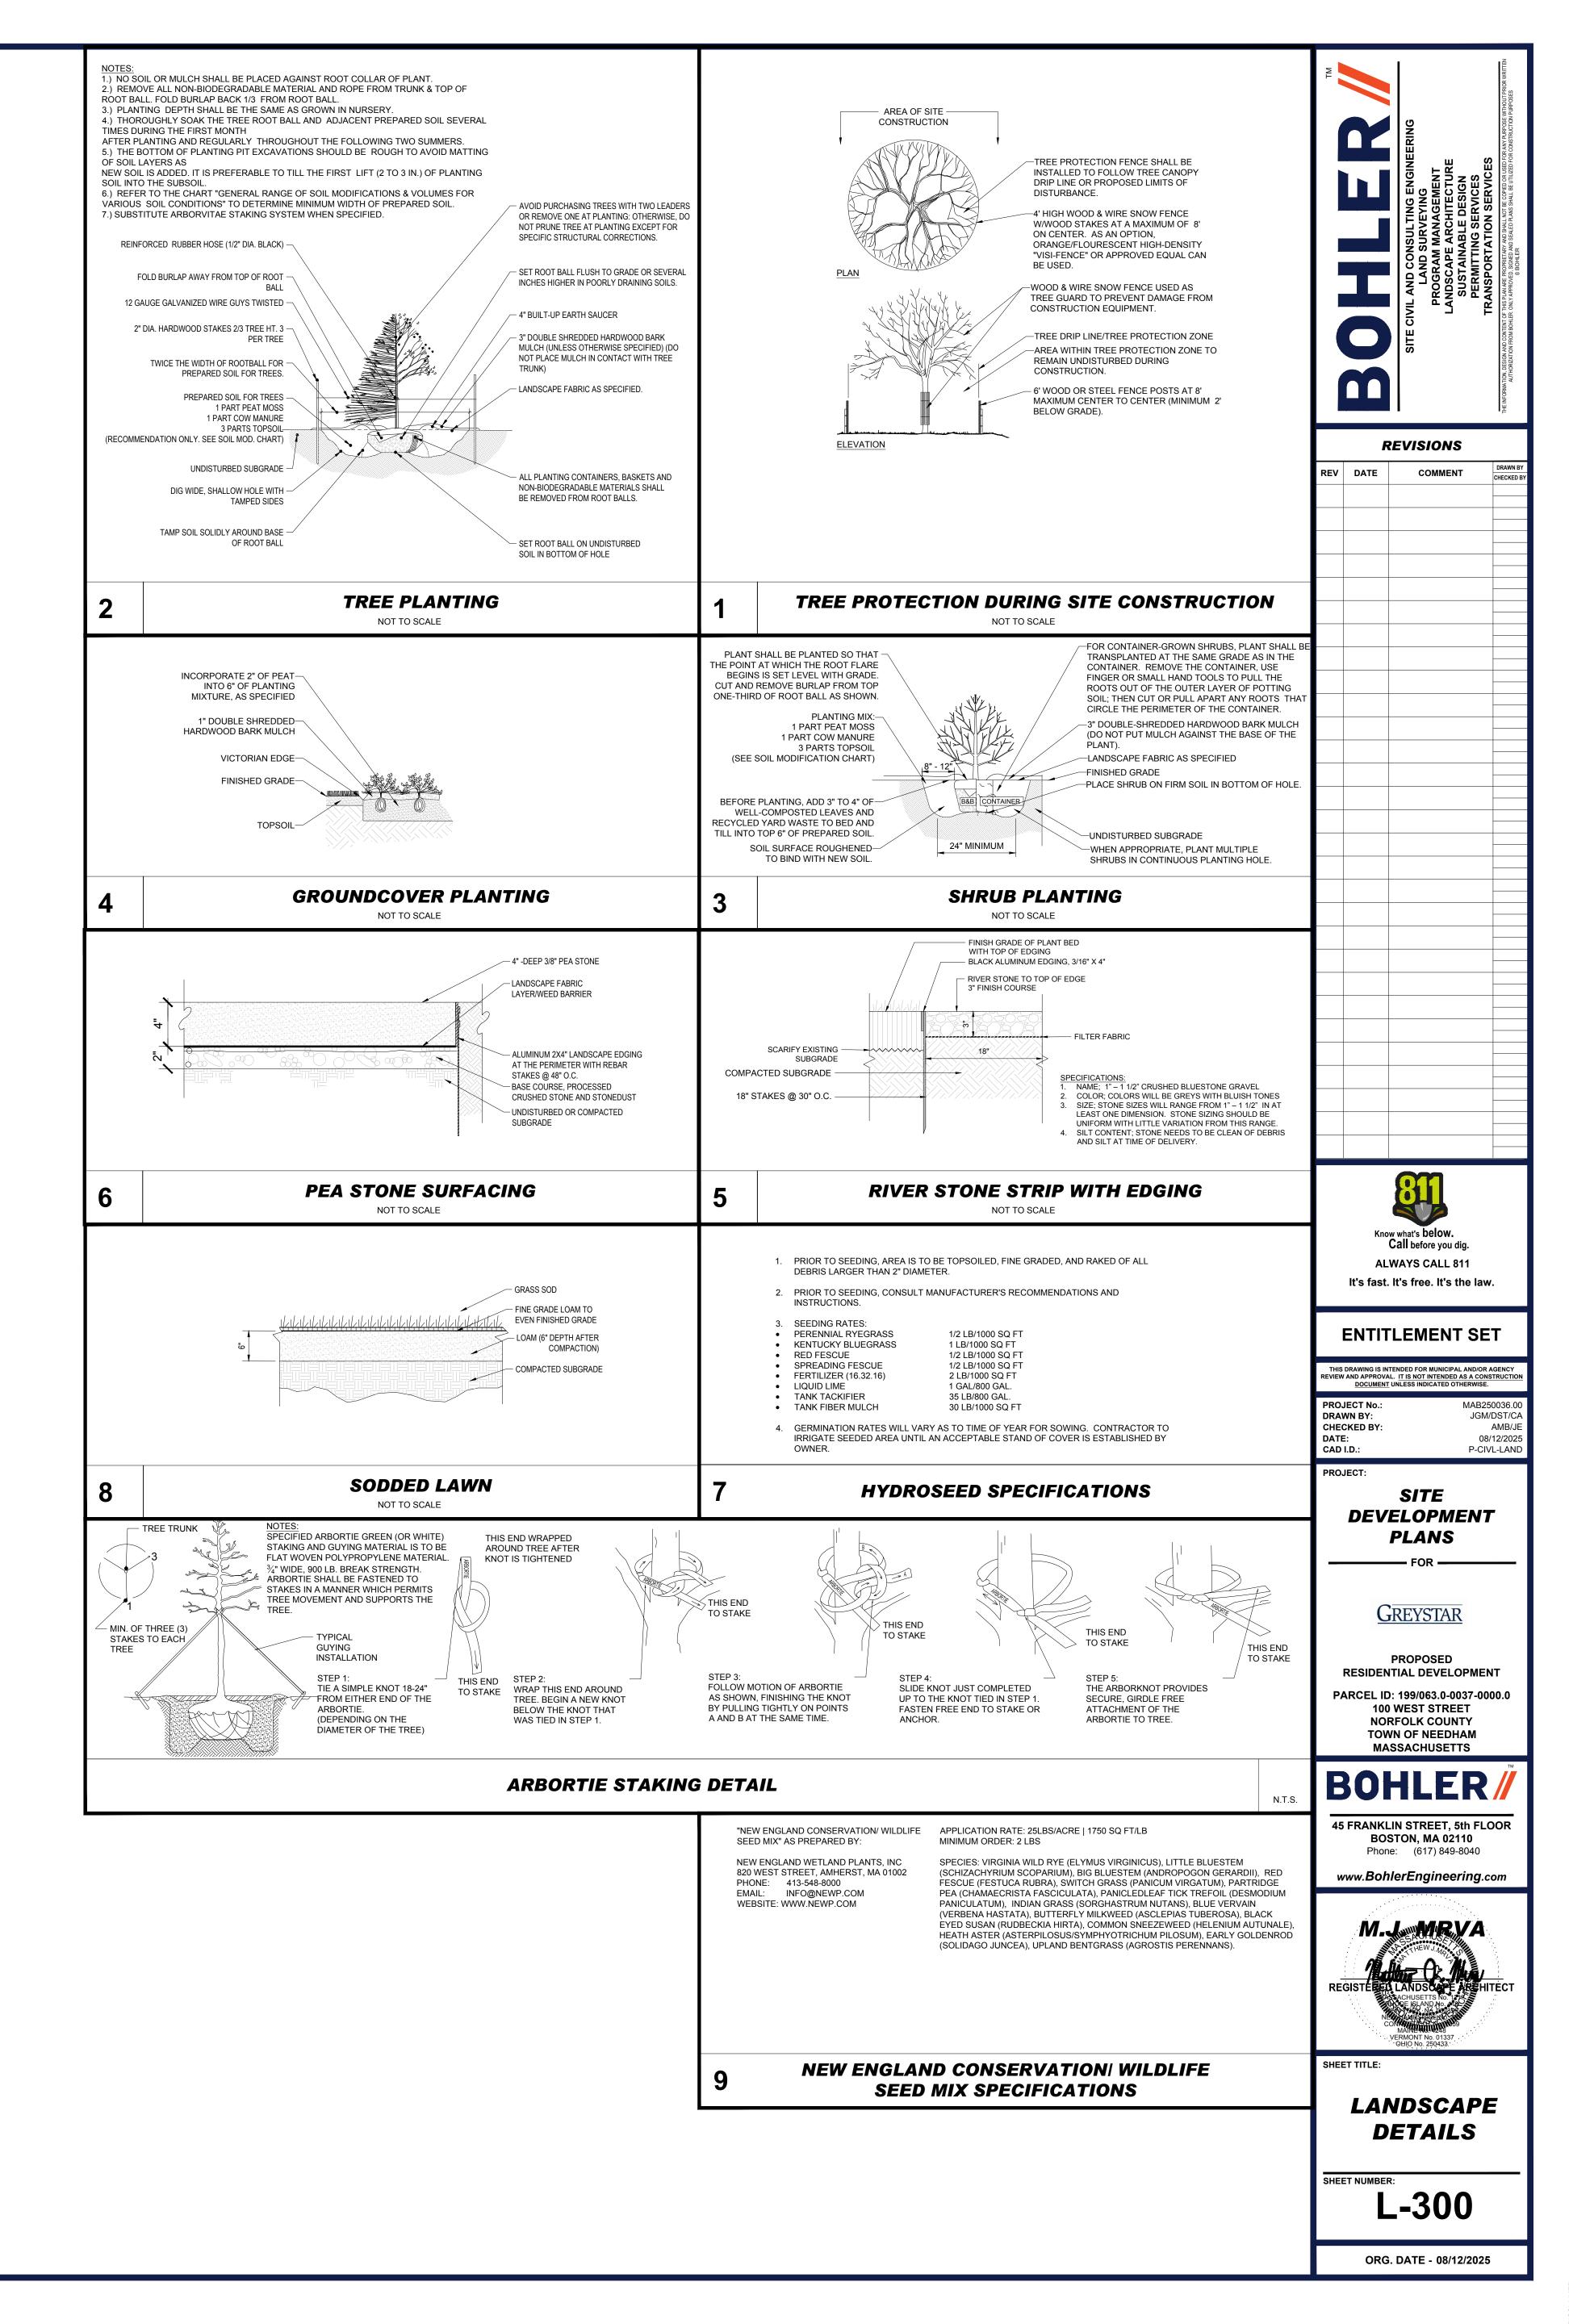

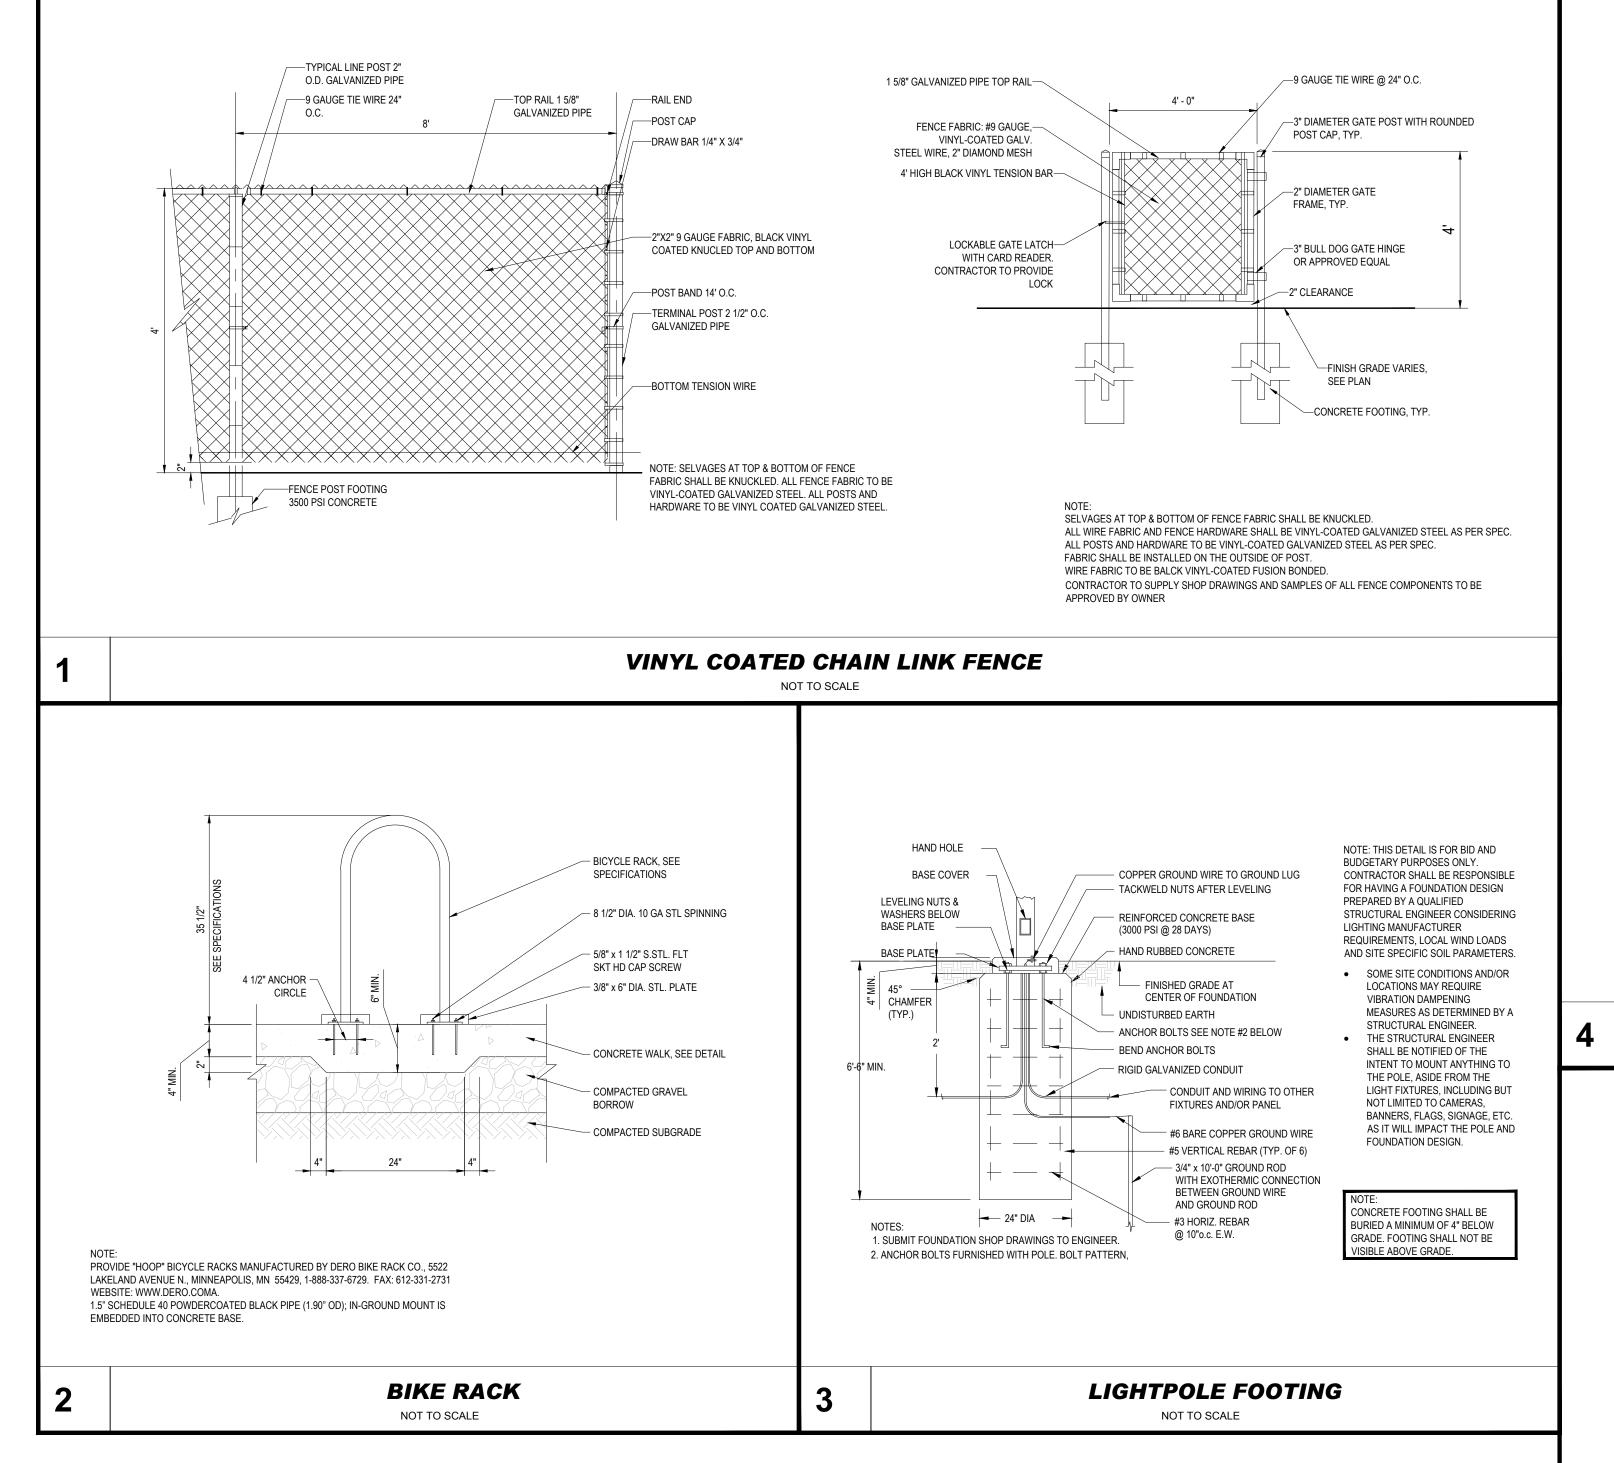

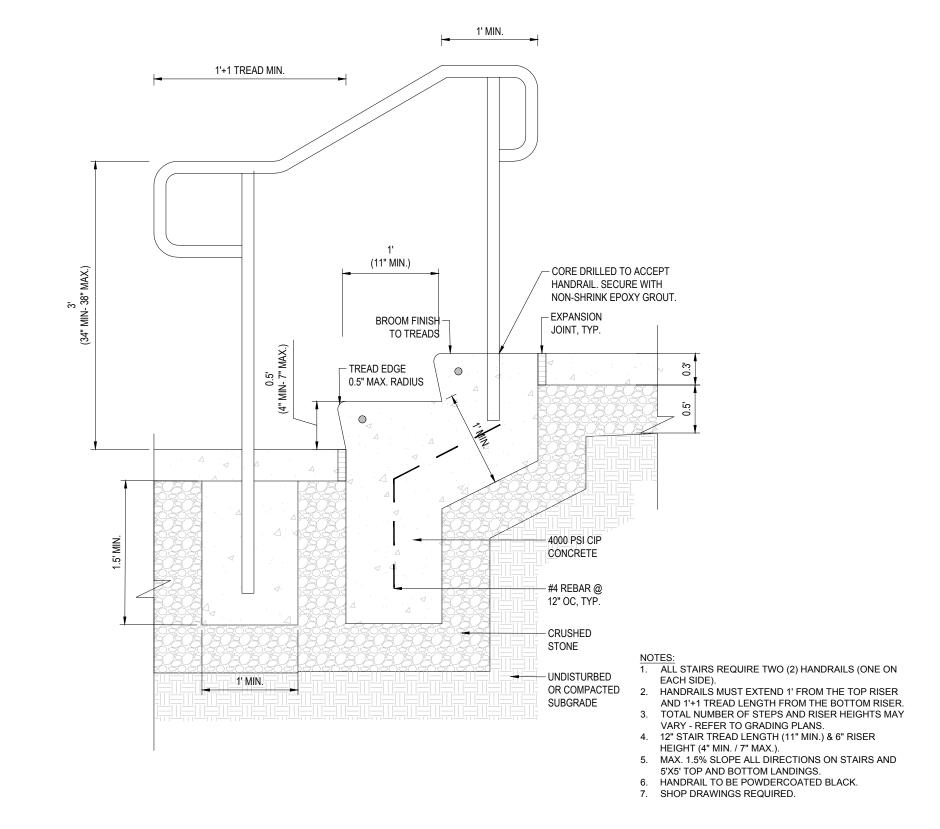

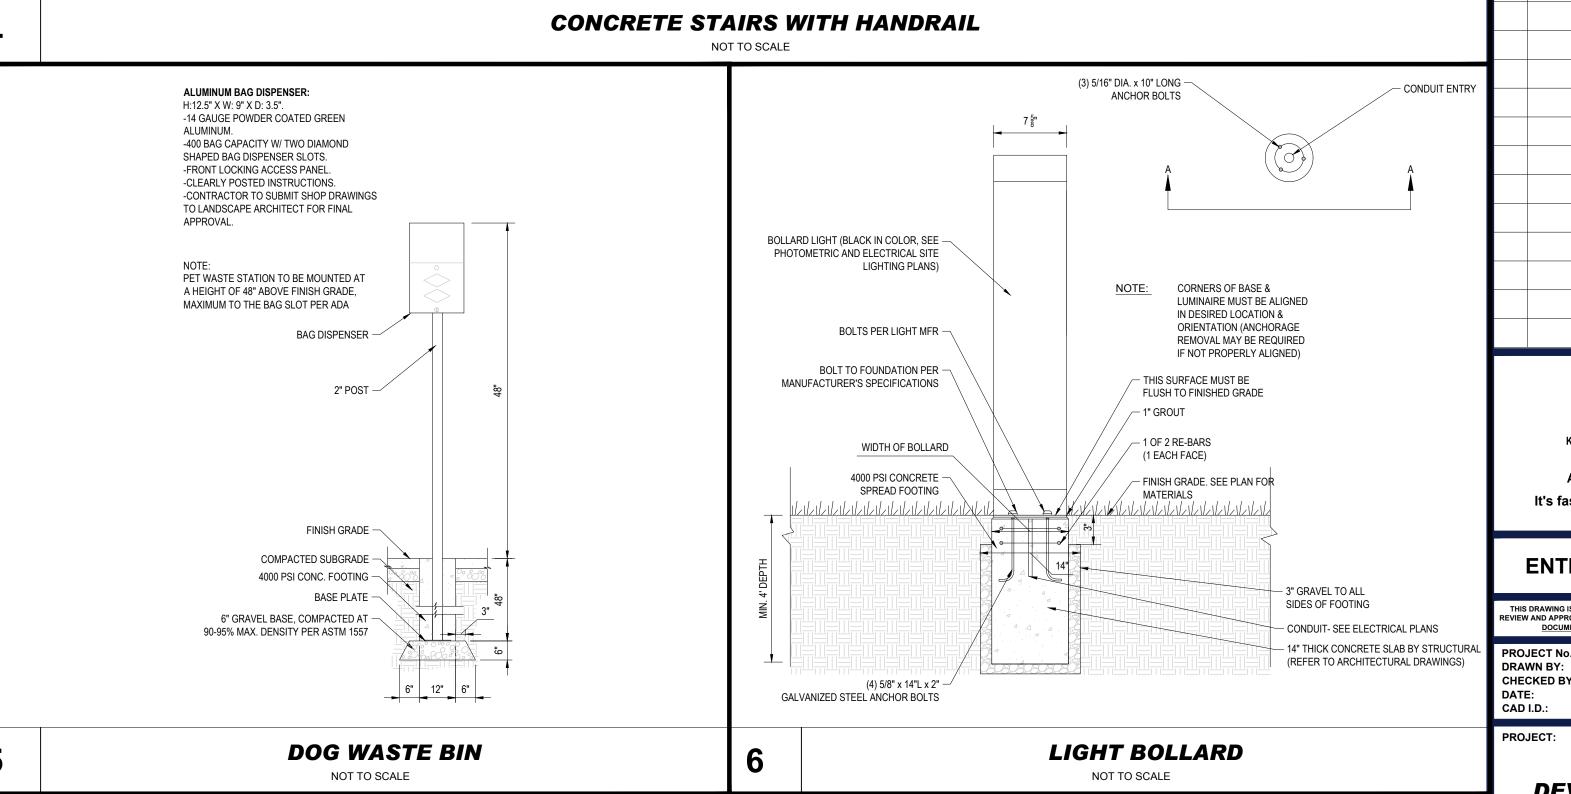




REVISIONS

REV DATE COMMENT

CHECK

C

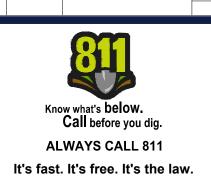

**ENTITLEMENT SET** 

THIS DRAWING IS INTENDED FOR MUNICIPAL AND/OR AGENCY REVIEW AND APPROVAL. IT IS NOT INTENDED AS A CONSTRUCTION DOCUMENT UNLESS INDICATED OTHERWISE.

PROJECT No.:

MAB250036.00

DRAWN BY:

JGM/DST/CA

CHECKED BY: AMB/JE
DATE: 08/12/2025
CAD I.D.: P-CIVL-LAND

PROJECT:

SITE
DEVELOPMENT
PLANS
FOR


<u>Greystar</u>

PROPOSED
RESIDENTIAL DEVELOPMENT

PARCEL ID: 199/063.0-0037-0000.0 100 WEST STREET NORFOLK COUNTY TOWN OF NEEDHAM MASSACHUSETTS

BOHLER//
45 FRANKLIN STREET, 5th FLOOR

BOSTON, MA 02110
Phone: (617) 849-8040
www.BohlerEngineering.com

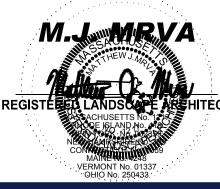



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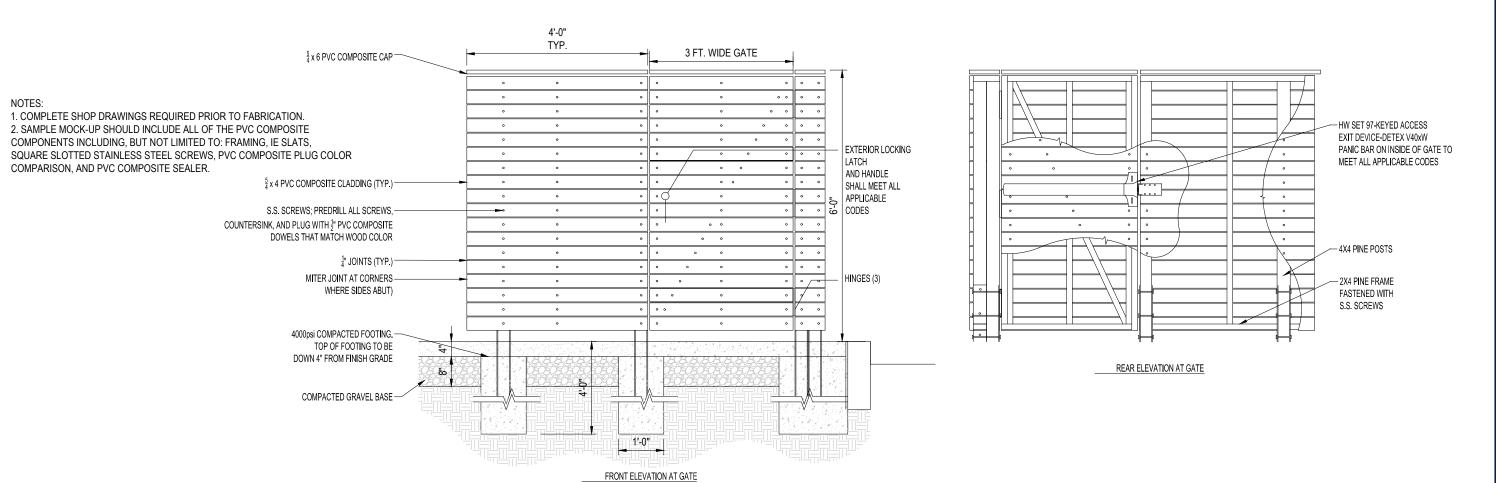
LANDSCAPE DETAILS

L-301

ORG. DATE - 08/12/2025



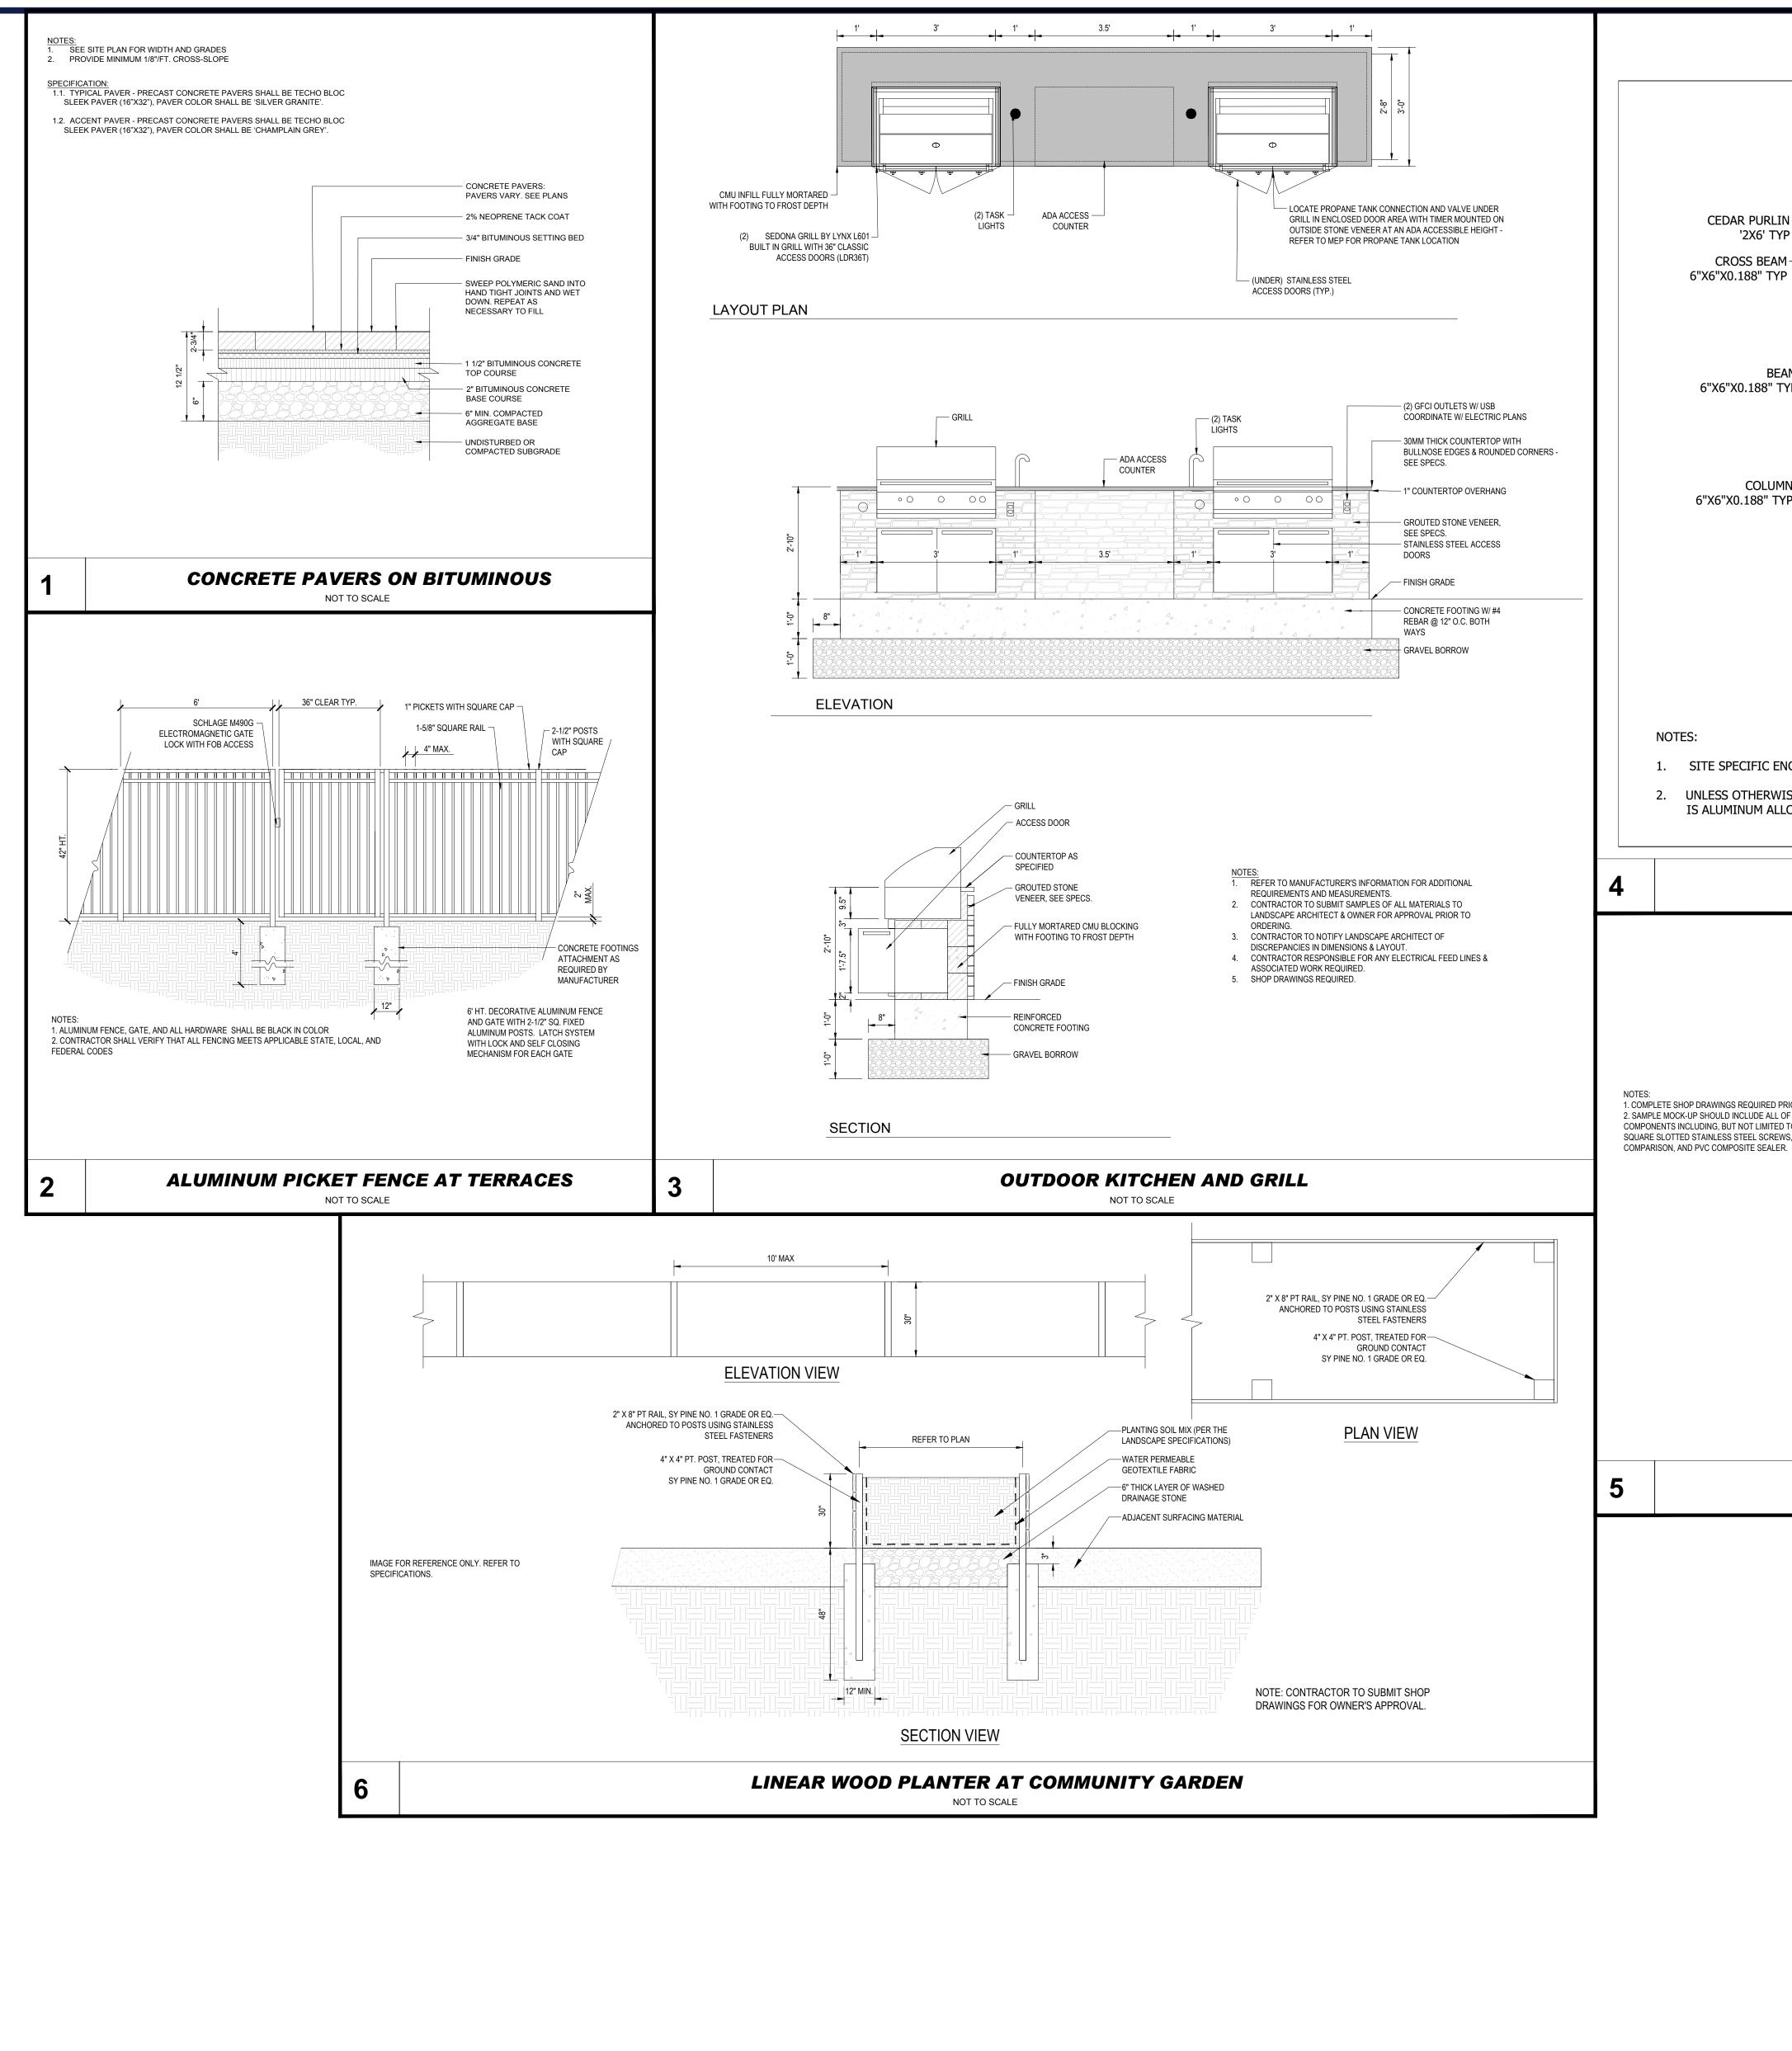

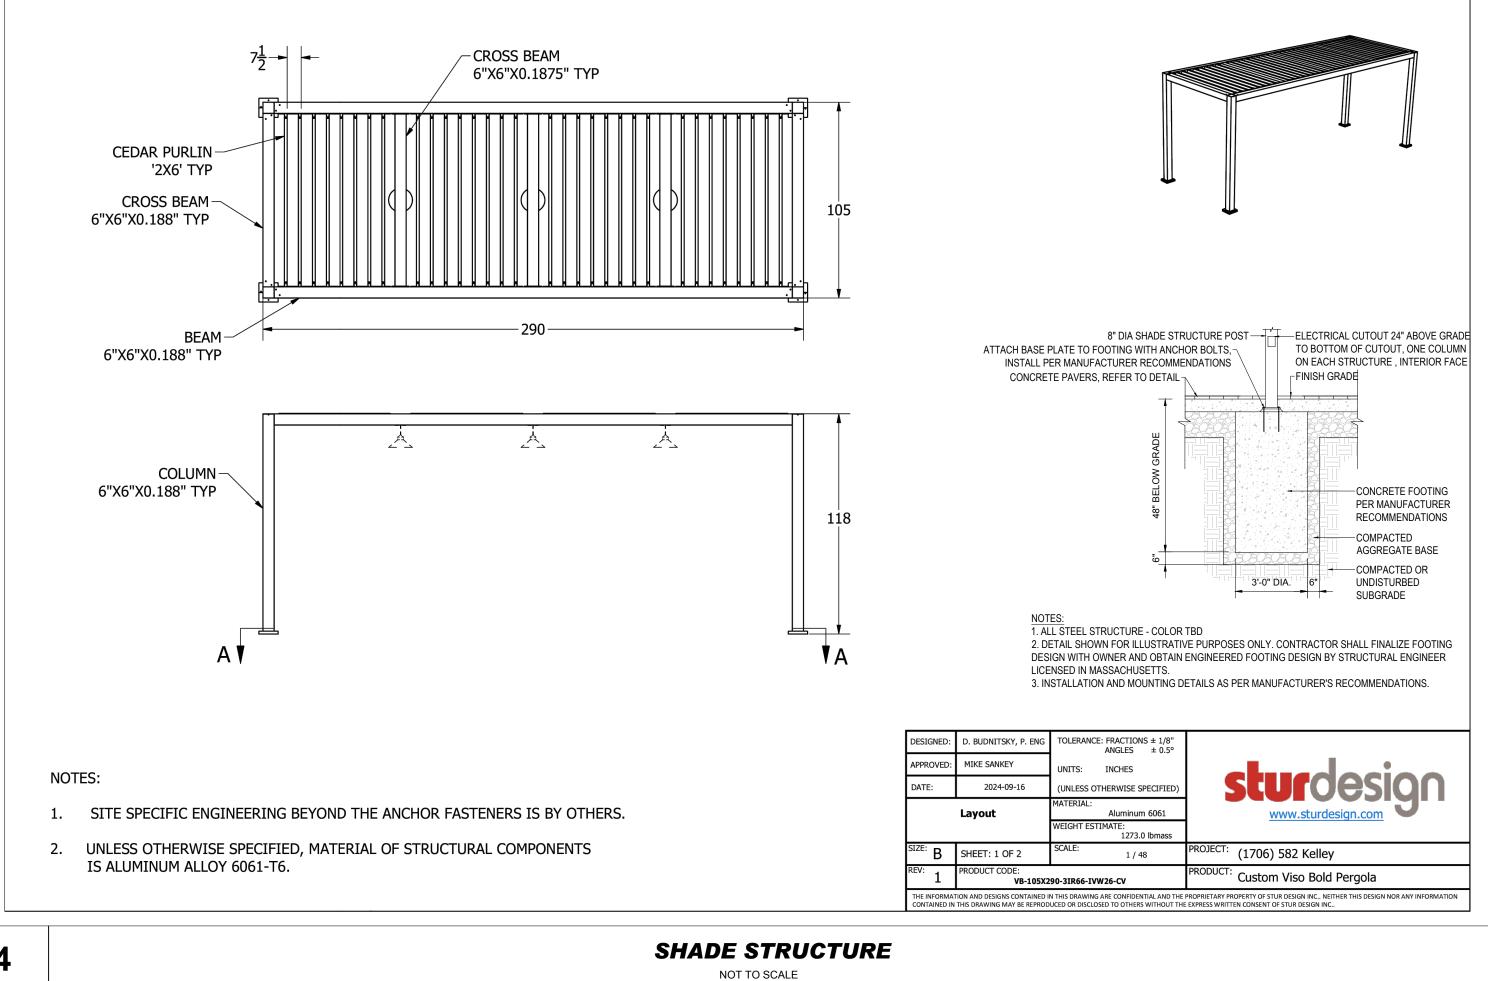

6' HT. TIMBER SCREEN AND GATE NOT TO SCALE

Know what's **below.** Call before you dig. **ALWAYS CALL 811** It's fast. It's free. It's the law.

**REVISIONS** 

COMMENT

REV DATE

**ENTITLEMENT SET** 

THIS DRAWING IS INTENDED FOR MUNICIPAL AND/OR AGENCY REVIEW AND APPROVAL. IT IS NOT INTENDED AS A CONSTRUCTI DOCUMENT UNLESS INDICATED OTHERWISE. PROJECT No.: DRAWN BY: JGM/DST/CA CHECKED BY:

08/12/2025

P-CIVL-LAND

CAD I.D.: PROJECT:

> SITE **DEVELOPMENT PLANS**

> > **G**REYSTAR


PROPOSED RESIDENTIAL DEVELOPMENT PARCEL ID: 199/063.0-0037-0000.0

100 WEST STREET NORFOLK COUNTY TOWN OF NEEDHAM **MASSACHUSETTS** 

45 FRANKLIN STREET, 5th FLOOR **BOSTON, MA 02110** 

Phone: (617) 849-8040 www.BohlerEngineering.com

M.J.WRVA

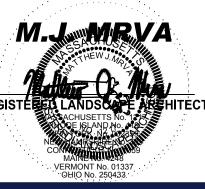



*LANDSCAPE* **DETAILS** 

L-302

ORG. DATE - 08/12/2025



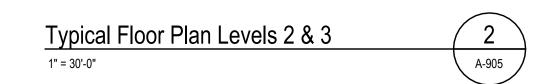

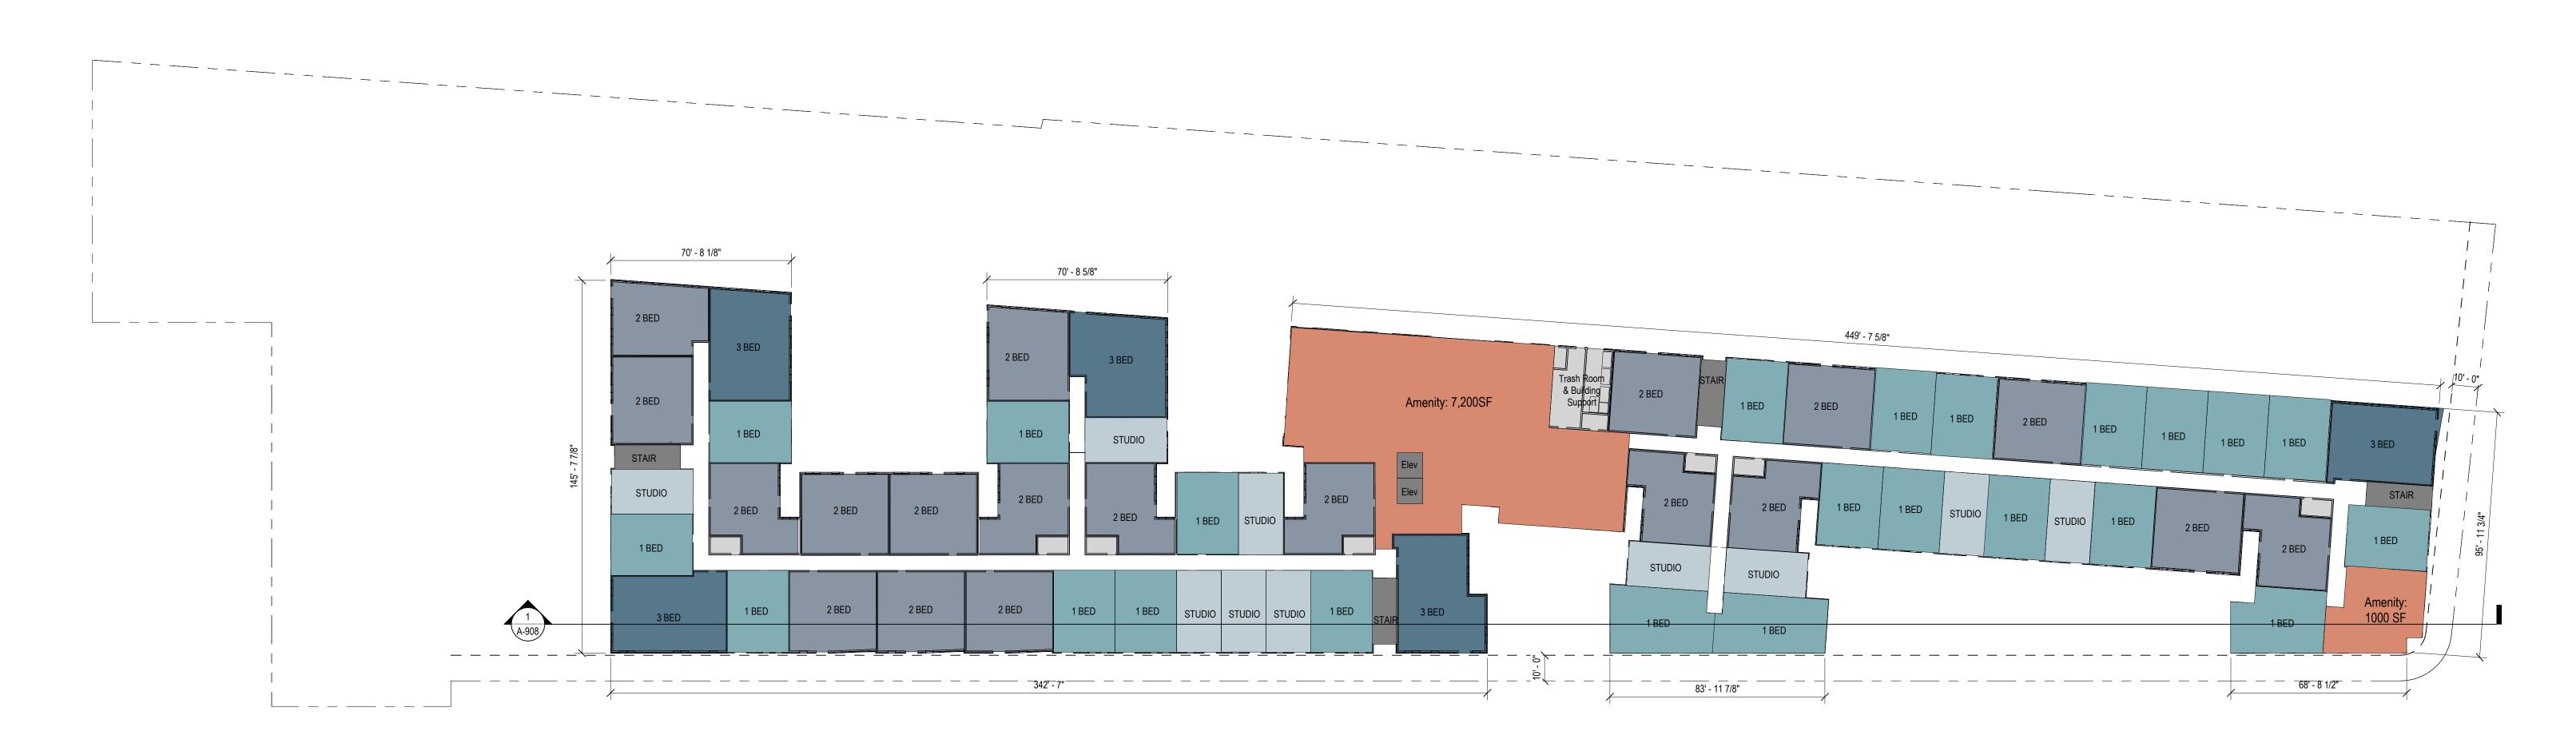


Ground Floor Plan

1" = 30'-0"

A-905



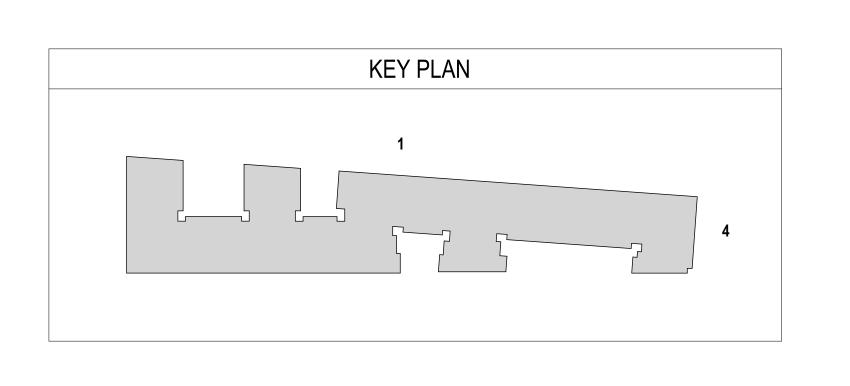



A-906

East Elevation








North Elevation

1" = 30'-0"

A-906

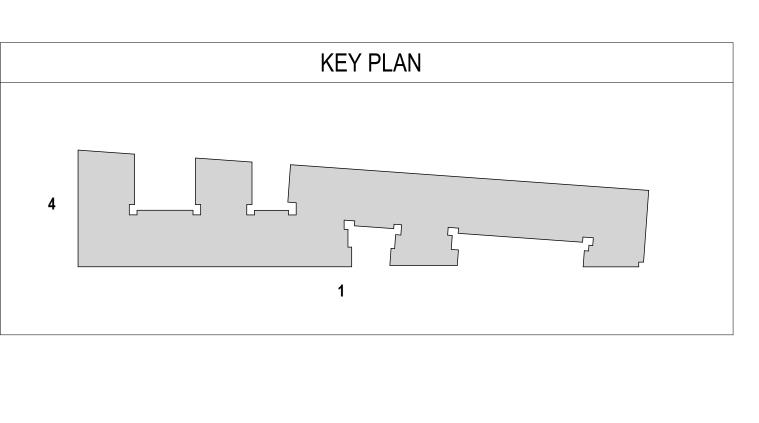







VERTICAL WOOD LOOK PANEL

2 A-908

Proposed Materials Elevation

3/32" = 1'-0"



Building Section


1" = 30'-0"


A-908








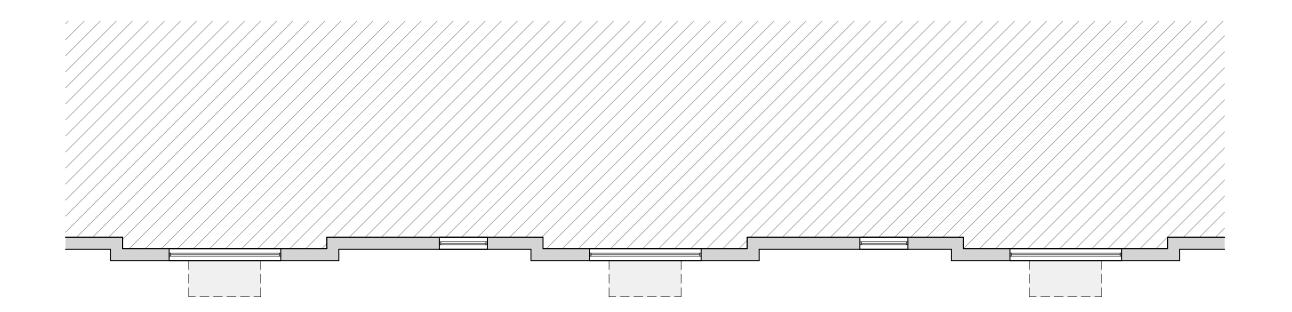

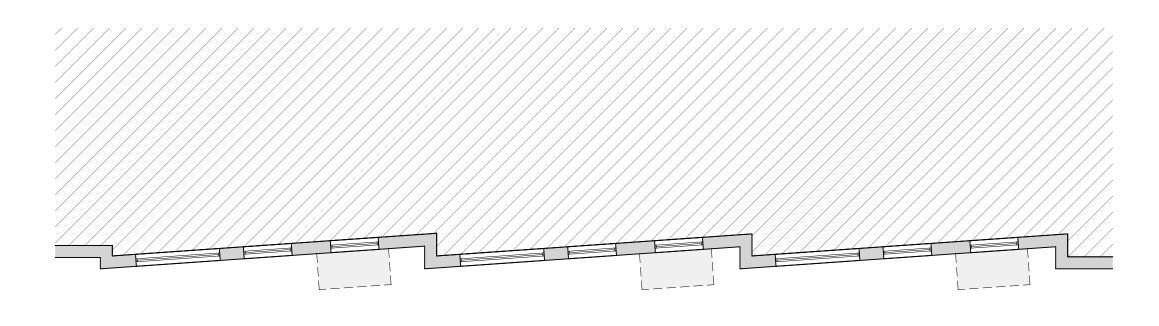

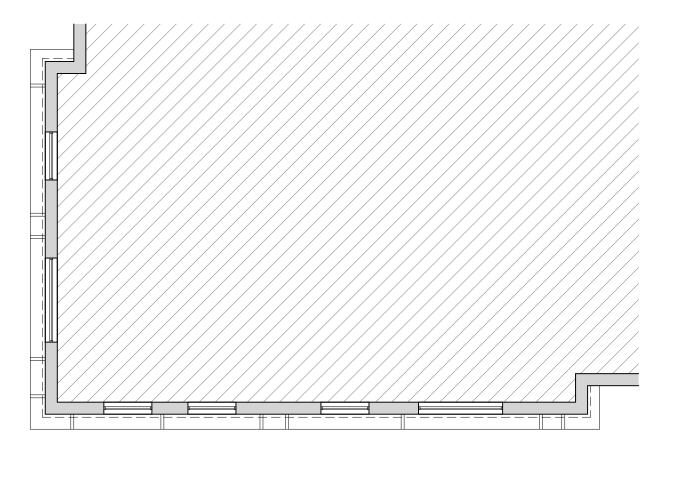

Detail View 3

3/16" = 1'-0"

A-909

Detail View 2

3/16" = 1'-0"

2

A-909

Detail View 1

3/16" = 1'-0"

A-909

# **Existing Site Photos**

SITE - 100 WEST STREET















1 2 **Design Review Board Meeting Minutes** Monday, August 11, 2025 3 7:30 p.m. 4 5 6 **Board Members:** Mark Gluesing, Board Chair (P) 7 8 Steve Dornbusch, Board Member (P) 9 Felix Zemel, Board Member (P) 10 Haril Pandya, Board Member (P) 11 Elisa Litchman, Administrative Specialist, Planning & Community Development (P) 12 13 Mark Gluesing, Chair, called the meeting to order on August 11, 2025, at 7:30 p.m. He reviewed 14 15 the remote meeting procedures. 16 17 **Applicants & Attendees:** 18 1. Annie So, owner of Highland Spa 19 2. Tom Taricano, FastSigns, representing Nightingale Wealth Solutions 20 21 Agenda Item 1: 22 Annie So, owner of Highland Spa located at 120 Highland Avenue and applying for signage and 23 an awning. 24 25 Annie So, owner of Highland Spa, explained that the proposed sign is designed to match the 26 plaza area. A sign is proposed on the building and a compound sign is proposed along the 27 roadside. The size requirements for the Town have been satisfied. 28 29 Mr. Dornbusch noted that the other pylon signs for the plaza have a white background, and the 30 proposed sign seems to have a different background. Chair Gluesing stated that some of the existing signs are faded but the proposed sign can be required to have a matching background. 31 32 Ms. So stated that the background would be made to match. 33 34 Mr. Dornbusch expressed concern that the light color and whited face letters would be hard to 35 see against the light building wall. It was noted there are other white faced signs on the 36 building. Ms. So stated that the sign will match the signs nearby. It was suggested, but not 37 required, that the applicant may want to use a darker letter box. 38 39 Mr. Zemel stated that the Board typically likes to see mockups from a sign company, versus an 40 AI created image. The submitted image shows a bright white sign which could be distracting. He 41 expressed concern regarding the brightness of the sign at this intersection. Chair Gluesing stated 42 that sign companies photoshop in an image, similar to what was submitted. The proposed sign is 43 internally, LED illuminated, similar to those next door. 44

Mr. Pandya stated that the drop shadow of the sign is not being shown in the images as it will be cast on the building. This could lead to the signs appearing to be quite bright. A filter effect could also have been used. A different rendering of these signs could address these concerns. He expressed concern regarding the use of gold and ivory colored sign, as the outline will be washed out. Depending on how bright the LED light is, the logo and lettering could become very difficult to read. The letters in the lower oval portion of the sign also do not seem centered.

Chair Gluesing stated that the letter cases on nearby signs have a darker color, which will allow them to read better during the day. He agreed that the sign may not be as visible as the applicant would like. The Board will require that the LED sign be dimmable which can then be observed once installed and dimmed if necessary.

Upon a motion duly made by Mr. Zemel and seconded by Mr. Dornbusch, it was voted to approve the parking lot sign, as submitted. Felix Zemel – aye; Haril Pandya – aye; Steve Dornbusch – aye; Mark Gluesing – aye; Motion passed 4-0-0.

Upon a motion duly made by Mr. Zemel and seconded by Mr. Dornbusch, it was voted to approve the Highland Ave sign, with the condition that the lighting be dimmable and that the lighting level be set to match the adjacent "Splash & Dash" and "Panera" signage, and that the wording in the oval box be centered. Felix Zemel – aye; Haril Pandya – aye; Steve Dornbusch – aye; Mark Gluesing – aye; Motion passed 4-0-0.

 Upon a motion duly made by Mr. Zemel and seconded by Mr. Dornbusch, it was voted to approve the pylon/compound sign, with the condition that the background color match the two adjacent signs [Splash and Dash and Landry Bicycles.] Felix Zemel – aye; Haril Pandya – aye; Steve Dornbusch – aye; Mark Gluesing – aye; Motion passed 4-0-0.

Upon a motion duly made by Mr. Zemel and seconded by Mr. Dornbusch, it was voted to approve the awning design, as submitted. Felix Zemel – aye; Haril Pandya – aye; Steve Dornbusch – aye; Mark Gluesing – aye; Motion passed 4-0-0.

#### **Agenda Item 2:**

Tom Taricano, FastSigns representing Nightingale Wealth Solutions located at 1036 Great Plain Avenue and applying for signage.

Tom Taricano, FastSigns representing Nightingale Wealth Solutions, explained that the proposal is for a fabricated aluminum pan face sign with 3D text and logo icon. The letters will be painted a single color per word. The logo will have vinyl on the front. The logo icon and "Nightingale" lettering will be ½" thick, the "Wealth Solutions" lettering will be ½" thick. The pan face will be 3" deep and mounted to the brick.

Mr. Dornbusch stated that he does not like the proposed location for the sign. This looks like a billboard on the building. He asked if one of the lower signs on the building could be moved over in order to make space for the proposed sign. Mr. Taricano stated that sometimes it is preferred to have the sign close to the actual location of the tenant, which is what is being proposed.

Mr. Pandya suggested aligning the sign in its proposed spot on the building with one of the signs below it.

Mr. Zemil stated that the precedent of installing this sign in its proposed location on the building could lead to someone requesting a sign for a tenant on the third story of the building. He asked if there is guidance in the ordinance for this. The Chair stated that there is not.

Mr. Taricano noted that moving the sign would locate it between the applicant's space and another tenant's space. Chair Gluesing stated that he would propose centering the sign over the Glamorous awning below.

Ariel Dangelo, Nightingale Wealth Solutions, stated that this space was chosen for the business due to its foot traffic but there has been confusion in finding the location in the past. The sign was chosen to help with this and keep with the branding. She would be accepting of moving the sign horizontally to the right to center it better. She noted that her lease states that if any of the other spaces in the building open up, her business has the first right to expand into that area.

 Chair Gluesing stated that the proportions for 36" tall signs generally do not work well. The graphic at the end gives the height for the sign. If this was shrunk to a 30" high panel, allowing for more space between the lettering and the graphic, it might make the sign clearer. Mr. Taricano stated that the applicant went through an extensive branding setup with the proposed proportions.

Chair Gluesing suggested centering the sign above the first window of the second floor on the right of the building and placing it above the first soldier course to more strongly tie it to the architecture. The other option would be to place a smaller sign at the first floor of the building, in line with the existing signs. Mr. Dornbusch stated that he would not approve of the second floor location.

Upon a motion duly made by Mr. Zemel and seconded by Mr. Dornbusch, it was voted to approve the sign, with the condition that the vertical centering remain as proposed, but that the sign be moved to the right and centered over the first window on the second floor. Felix Zemel – aye; Haril Pandya – aye; Steve Dornbusch – nay; Mark Gluesing – aye; Motion passed 3-1-0.

- REVIEW
- 127 Minutes of 7/14/2025 minutes

Upon a motion duly made by Mr. Zemel and seconded by Mr. Dornbusch, it was voted to
 approve the meeting minutes of July 14, 2025. Felix Zemel – aye; Haril Pandya – abstain; Steve
 Dornbusch – aye; Mark Gluesing – abstain; Motion passed 2-0-2.

Upon a motion duly made by Mr. Zemel and seconded by Mr. Dornbusch, it was voted to adjourn at 8:26 p.m. Felix Zemel – aye; Haril Pandya – aye; Steve Dornbusch – aye; Mark Gluesing – aye; Motion passed 4-0-0.



